#### ROAD USE AGREEMENT

THIS AGREEMENT effective this /2" day of November, 2013 (the "Effective Date")

BETWEEN:

#### THE CORPORATION OF THE COUNTY OF MIDDLESEX

(hereinafter referred to as the "County")

OF THE FIRST PART

- and -

#### JERICHO WIND, INC.

a corporation established under the laws of the Province of New Brunswick (hereinafter referred to as "**Jericho**")

#### OF THE SECOND PART

#### WHEREAS:

- A. the County is a municipal corporation with the meaning of the *Municipal Act, 2001*, S.O. 2001, c. 25, as amended, is governed by Warden and Council and operated by Administration, which is hereby authorized to administer this Agreement in its entirety, including but not limited to decisions with respect to the operation and termination of this Agreement in accordance with its provisions;
- B. the County exercises jurisdiction with respect to approval of certain activities with respect public rights of way, highways, streets, sidewalks, walkways, driveways, ditches and boulevards within the County of Middlesex;
- C. Jericho is a wind farm owner/operator, has a current registered corporate identity in New Brunswick; has an office and mailing address at 390 Bay Street, Suite 1720, Toronto, ON M5H 2Y2; and is operational out of 700 Universe Blvd., Juno Beach, Florida 33408;
- D. Jericho is the owner of the Wind Project, as defined herein;
- E. Jericho is the owner of the Power Purchase Agreement for the Wind Project, all assets of the Wind Project, as provided in the Jericho Asset Document, which is attached hereto as <u>Schedule "A"</u>, forms a part of this Agreement but shall be treated as confidential between the parties to extent possible under Applicable Law;
- F. the County owns the roads identified in the Approved Road Use Plans, which is attached hereto as **Schedule "B"** and forms a part of this Agreement;

- G. Jericho wishes to make use of certain roads located in the County of Middlesex to allow for construction, operation and maintenance of the Wind Project and to deliver components and materials thereto;
- H. pursuant to section 50(3)(d.1) of the *Planning Act*, as amended, the Parties may enter into an agreement that has the effect of granting a use of or right in land directly or by entitlement to renewal for a period of more than twenty-one years;
- I. the County and Jericho enter into this Agreement with respect of the use, installation, construction, maintenance and operation of certain Transmission Infrastructure on, over, under and within the Road Allowances, as defined herein;
- J. subject to Provincial legislation and Ontario Energy Board Approval, and the terms and conditions set forth below with respect to the use of County Road Allowances, the County acknowledges Jericho's right to install, construct, maintain, operate and decommission such Transmission Infrastructure over, along, across or under Road Allowances;
- K. subject to obtaining an access/work permit from the County for non-electricity transmission related work, Jericho shall have the right to temporarily reconstruct or realign certain portions of the Road Allowances to permit delivery or movement of oversized Wind Project components, including wind turbine blades, tower sections and nacelles;
- L. subject to obtaining an access permit from the County, Jericho shall have the right to connect access roads from Wind Project turbines to the Road Allowances to permit ongoing access to the wind turbines during Wind Project operations; and
- M. Jericho warrants that all times throughout the Term of this Agreement, including its option periods, it shall retain assets which have a minimum value of \$5 million dollars.

**NOW THEREFORE THIS AGREEMENT WITNESSETH THAT**, in consideration of the payment of the sum of TWO DOLLARS (\$2.00) from each Party to the other and other good and valuable consideration, including the terms, covenants and provisions herein, the receipt and sufficiency of which is hereby acknowledged and agreed, the Parties covenant and agree as follows:

#### A. <u>INTERPRETATION</u>

- 1. The above recitals are true and the same are hereby incorporated into this Agreement by reference.
- 2. Each obligation of the Parties hereto contained in this Agreement, even if not specifically expressed as a covenant, shall be considered for all purposes to be a covenant. Each covenant in this Agreement is a separate and independent covenant and a breach of covenant by any Party will not relieve any other Party from its obligation to perform each of its covenants; except as otherwise provided herein.

#### Definitions

- 3. In this Agreement, in addition to terms defined elsewhere in this Agreement, the following terms have the following meanings:
  - (a) **"Agreement"** means this Agreement, including all Schedules, as it may be confirmed, amended, modified, supplemented or restated by written agreement between the Parties.
  - (b) "Anti-Bribery Laws" mean any anti-bribery law or international convention, as may apply now or in the future, including the Canadian Corruption of Foreign Public Officials Act, the U.S. Foreign Corrupt Practices Act, the U.K. Bribery Act and the OECD Convention on Combating Bribery of Foreign Public Officials.
  - (c) "Applicable Law" means all present or future applicable laws, statutes, regulations, treaties, judgments and decrees and all present or future applicable published directives, rules, policy statements and orders of any Public Authority and all applicable orders and decrees of courts and arbitrators of like application to the extent, in each case, that the same are legally binding on the Parties in the context of this Agreement.
  - (d) "Appropriate Emergency Service Providers" means those emergency service providers set out in <u>Schedule "C"</u>, which is attached hereto and forms a part of this Agreement;
  - (e) **"Approved Road Use Plans"** means the diagrams attached as <u>Schedule "B"</u> hereto depicting the location of and other aspects in relation to Transmission Infrastructure in Road Allowances, as approved by the County Engineer prior to the execution of this Agreement.
  - (f) **"As-Built Plan"** means a Plan following the placement, installation, construction, re-construction, inspection, maintenance, operation, alteration, enlarging, repairing, replacing, relocating and removing Transmission Infrastructure confirming the exact location and specifications of any Transmission Infrastructure installed over, along, across, under or within the Road Allowances.
  - (g) "**Business Day**" means any day excluding a Saturday, Sunday or statutory holiday in the Province of Ontario, and also excluding any day on which the principal chartered banks located in the Municipality of Strathroy-Caradoc are not open for business during normal banking hours.
  - (h) **"Commercial Operation Date"** means the Commercial Operation Date as defined in the Power Purchase Agreement, as defined herein.
  - (i) **"County Engineer"** means the individual designated to serve in that position for the Corporation of the County of Middlesex duly passed via municipal by-law.

- (j) **"Deliveries"** means the transporting of materials, components and equipment including overweight or over-size cargoes across or along Road Allowances, to provide for the construction, maintenance, repair, replacement, relocation or removal of wind turbines and other infrastructure for the Wind Project.
- (k) **"Easement Rights"** means the right to place, install, construct, re-construct, inspect, maintain, operate, alter, enlarge, repair, replace, relocate and remove Transmission Infrastructure over, along, across, within or under the Road Allowances provided for this Agreement.
- (l) "Entrance(s)" means one or more points of access across and through the Road Allowances from the travelled portion of the Road Allowances connecting to private lands beyond and certain access roads in and upon adjacent lands used in connection with the Wind Project, which has been approved by the County Engineer
- (m) **"Entrance Work**" means the constructing and maintaining of Entrances to private wind turbine access roads.
- (n) **"Municipal Infrastructure"** means structures, services or facilities of any kind owned or operated by or for the benefit of the County, including drains, water mains and culverts.
- (o) **"Parties"** means the County and Jericho collectively, and **"Party"** means any one of them.
- (p) "Permits" means those permits required to be obtained by Jericho from the County for the purposes of performing the Work and for the purposes of use of the Road Allowances, along with all requirements for the issuance of such Permits and all fees associated with such Permits, as set out in the Permits and Fees Document, which is attached hereto as <u>Schedule "D"</u> and forms a part of this Agreement.
- (q) **"Plan"** means a detailed plan drawn to scale, which:
  - (i) identifies the location, size and elevation of the Transmission Infrastructure;
  - (ii) demonstrate that the installation of the Transmission Infrastructure will comply with applicable safety, technical and regulatory standards and the requirements of Applicable Law;
  - (iii) show the Road Allowances where the installation of Transmission Infrastructure is proposed and the location of the proposed Transmission Infrastructure or part thereof together with specifications relating to the proposed Transmission Infrastructure or part thereof; and
  - (iv) shows the "no winter maintenance" Road Allowances within the County.

- (r) **"Plans"** means more than one Plan, as defined herein, referred to collectively.
- (s) "**Power Purchase Agreement**", (sometimes hereinafter "**PPA**") means the Feed-In Tariff Contract made between Jericho and the Ontario Power Authority, including any amendments or renewals thereof.
- (t) **"Public Authority"** means any governmental, federal, provincial, regional, municipal or local body having authority over the County, Jericho, the Wind Project, the Transmission Infrastructure or the Road Allowances.
- (u) "**Repair Work**" means work involving the maintenance, repair and replacement of the Wind Project, including the maintenance, repair and replacement of installed Transmission Infrastructure and Entrances that does not cause the location, elevation, position, layout or route of the Transmission Infrastructure or Entrances to materially change.
- (v) "Road Allowances" means public rights of way, road allowances, streets, sidewalks, highways, walkways, driveways, ditches and boulevards and the allowances therefor, and includes all existing infrastructure located on or within the Road Allowances, all owned, or managed under the legal jurisdiction of the County as shown in the Approved Road Use Plans (<u>Schedule "B"</u>).
- (w) "Secured Party" or "Secured Parties" means Jericho's lenders, from time to time.
- (x) **"Transmission**" means the conveyance of electricity at voltages in excess of 50 kilovolts.
- (y) **"Transmission Infrastructure**" means infrastructure conveying electricity at voltages in excess of 50 kilovolts and includes all structures, equipment or other things used for that purpose including, but not limited to, a line or lines of towers and/or poles, with such wires and/or cables for the transmission of electricity at voltages in excess of 50 kilovolts, and all necessary and proper foundations, safety barriers, footings, cross arms and other appliances, facilities and fixtures for use in connection therewith including without limitation, pads, vaults and junction boxes manholes, handholes, conduits, fiber optics, cables, wires, lines and other conductors of any nature, multiple above or below ground control, communications, data and radio relay systems, and telecommunications equipment, including without limitation, conduits, fiber optics, cables, wires and lines.
- (z) "**Transmission Infrastructure Work**" means the installing, constructing, operating, inspecting, maintaining, altering, enlarging, repairing, replacing, relocating and removing of Transmission Infrastructure over, along, across, within or under the Road Allowances in connection with the Wind Project.
- (aa) **"Tree Work**" means the cutting, trimming, removing or replacing of trees or bushes growing in or extending into, over or under the Road Allowances.

- (bb) **"Wind Project"** means the 150 megawatt renewable energy generating facility known as Jericho Wind Energy Centre and its appurtenant wind turbines, equipment, buildings and Transmission Infrastructure, a portion of which is to be constructed in the County of Middlesex for the purpose of supplying electricity in accordance with the PPA.
- (cc) "**Work**" means all work required to be performed by Jericho pursuant to the terms of this Agreement, including, but not limited to, all Deliveries, Transmission Infrastructure Work, Entrance Work, Tree Work, and Repair Work.

#### Schedules

4. The following schedules to this Agreement are an integral part of this Agreement:

Schedule "A"	Jericho Asset Document
	Shows type and value of all current assets owned by Jericho
Schedule "B"	Approved Road Use Plans
	Geographically shows the location of the Wind Project; municipal description and location of County Road Allowances (including those Road Allowances which are not subject to winter maintenance); and particulars with respect of the route of Transmission Infrastructure, including but not limited to location of poles , engineering details of poles (type, material, size, foundation, construction methods, guying details.), electrical transmission line arrangement (height of cables, vertical clearances, expected cable sag/sway, etc.), and the location of any alteration of the County Road Allowances in relation to the installation of said transmission facilities (ditch grading and guardrails).
Schedule "C"	Appropriate Emergency Service Providers
Schedule "D"	Permits and Fees
	Shows all Permits and fees required to be applied for and obtained by Jericho from the

Rights and Remedies afforded to Secured Parties

#### **Statutory Rights**

Schedule "E"

5. The Parties agree that nothing contained in this Agreement shall abrogate or prejudice any statutory rights held by any Party under any applicable statute, including but not limited to the *Municipal Act, 2001*, as amended, *the Ontario Energy Board Act, 1998*, as amended, the *Green Energy and Green Economy Act, 2009*, as amended and the *Electricity Act, 1998*, as amended.

#### B. <u>GRANT OF PERMISSION</u>

#### Term

6. The rights provided for in this Agreement shall be for a term which is the greater of: (i) thirty (30) years from the Effective Date plus an option in favour of Jericho to extend the term of this Agreement for two (2) further ten (10) year periods, or (ii) from the Effective Date to the expiry of the term of the PPA and any extensions thereof, together with such additional time (not to exceed nine (9) months) as may be reasonably required to complete the decommissioning of the Wind Project, (hereinafter, the "**Term**").

#### **Grant of Easement**

7. The County hereby grants and transfers to Jericho for the duration of the Term, the nonexclusive right, privilege, interest, benefit and easement to enter upon and use the Road Allowances as identified in the Approved Road Use Plans (<u>Schedule "B"</u>) with such persons, vehicles, equipment and machinery as may be necessary for the purpose of placing, installing, constructing, re-constructing, inspecting, maintaining, operating, altering, enlarging, repairing, replacing, relocating and removing Transmission Infrastructure and the right to perform Work over, along, across, within or under the Road Allowances in connection with the Wind Project, subject to the following conditions:

#### **Prior Approvals**

(a) Jericho, prior to the installation, placement, installation, construction, reconstruction, inspection, maintenance, operation, alteration, enlarging, repair, replacement, relocation and/or removal of any Transmission Infrastructure over, along, across, within or under the Road Allowances, shall obtain the approval of any Public Authority required by or have the authority pursuant to Applicable Law in connection with such activity.

Notice

(b) Jericho shall make its best effort, prior to the installation, placement, installation, construction, re-construction, inspection, maintenance, operation, alteration, enlarging, repair, replacement, relocation and/or removal of any Transmission Infrastructure over, along, across, within or under the Road Allowances, to provide notice of all other existing Road Allowance users of the aforementioned installation, placement, installation, construction, re-construction, inspection, maintenance, operation, alteration, enlarging, repair, replacement, relocation and/or removal of any Transmission Infrastructure over, along, across, within or under the Road Allowance users, within or under the Road Allowance.

#### Transmission Infrastructure Placement

(c) All Transmission Infrastructure shall be installed above-grade within the Road Allowances in the location specified in the Approved Road Use Plans (<u>Schedule</u> <u>"B"</u>) within a reasonable error range and supported by stand facilities (poles) at an appropriate elevation to avoid incompatibilities and/or conflicts with other existing infrastructure;

#### Distance from Travelled Portion and Property Line

- (d) The Parties agree that Jericho shall make commercially reasonable efforts to install Transmission Infrastructure in the following locations within the Road Allowances:
  - (i) in locations between the outer limit of the travelled portion of the relevant Road Allowance and the property line of the Road Allowance;
  - (ii) at depths and/or elevations within the relevant Road Allowance to avoid incompatibilities and/or conflicts with existing infrastructure and, using commercially reasonable efforts, to avoid incompatibilities and/or conflicts with currently planned infrastructure; and
  - (iii) in consistent locations within the Road Allowances such that the number of road crossings is minimized.

#### Permits/Fees

(e) Jericho will obtain all Permits from the County and pay the appropriate fees associated with obtaining the same, which fees are shown in the Permits and Fees Document (<u>Schedule "D"</u>). The County shall issue all such Permits within the timelines set out in the County's by-laws or in the relevant statutes or regulations or thirty (30) days following receipt from Jericho of its applications and fees, whichever is less, and, without limiting the generality of the foregoing, in respect of grading, guardrails and culverts related to the Transmission Infrastructure, shall issue the applicable work permit on the basis of standards typically applied in accordance with the Road Safety Manual;

#### Legal Compliance

(f) All actions of Jericho and the County shall be in compliance with Applicable Law;

#### Insurance Coverage

(g) Jericho agrees that prior to the placing, installing, constructing, re-constructing, inspecting, maintaining, operating, altering, enlarging, repairing, replacing, relocating and removing Transmission Infrastructure over, along, across, within or under the Road Allowances, Jericho shall arrange for and maintain commercial general liability insurance (hereinafter, the "CGL"), insuring Jericho and naming the County as an additional insured. The CGL shall provide, at a minimum limits of liability, not less than five million dollars (\$5,000,000.00) per incident and in the aggregate. In addition, the CGL shall contain a cross liability and severability of interest clause and provide for a minimum of ten (10) days' notice of cancellation of the CGL. Jericho shall upon written request thereof, deliver to the County, from time to time and in any event prior to commencement of the Work, a copy of a certificate of insurance evidencing that the CGL is in full force and effect.

#### Commencement of Work

- (h) Prior to the commencement of any Work, Jericho shall document, by means of a video recording or other means satisfactory to the County, acting reasonably, the then-existing condition of all Road Allowances or structures that Jericho expects will or may be used for or subject to Work, and both Parties shall receive a complete copy of such video recording or document;
- (i) Jericho agrees to maintain the surface of the Road Allowances for a period of twelve (12) months following the Commercial Operations Date and restore the surface of the Road Allowance to at least the same condition as prior to the commencement of any Work, except in the cases where the alteration to the untraveled potion of the Road Allowance forms part of the Work;
- (j) Jericho agrees the Easement Rights shall be exercised and carried out in a good, safe and workmanlike manner;
- (k) Jericho shall be responsible for any damage caused to the Road Allowances at any time by itself, its agents, employees or contractors and for removing all debris from the work area following the undertaking of any of the Easement Rights contemplated herein;

- (1) Jericho shall make commercially reasonable efforts to protect the integrity and security of all existing equipment, installations, utilities, and other facilities within the Road Allowance or which might otherwise be located in, on, or under the Road Allowances or any adjacent lands;
- (m) Jericho shall make all payments and taking all such steps as may be reasonably necessary to ensure that no construction lien or other lien is registered against the Road Allowances as a result of the undertaking by Jericho of any of the Easement Rights or any other work contemplated in this Agreement and taking such steps as may be required to cause any such registered lien or claim for lien to be discharged or vacated immediately after notice thereof from the County is provided to Jericho.

#### **Non-Exclusive Permission**

- 8. The Easement Rights provided for in this Agreement shall constitute a non-exclusive easement. Without limiting the foregoing, the Easement Rights are subject to the rights of the owners of the property adjoining the Road Allowances who are entitled access to and from the Road Allowances from their properties, and subject to the rights and privileges that the County may grant to other persons on the Road Allowances, all of which rights are expressly reserved, the rights shown on the Approved Road Use Plans and As-Built Plan and specifications only excepted. Jericho hereby acknowledges and agrees that there are other utilities and third parties that do and/or may have similar rights over the Road Allowances and Jericho hereby agree to make commercially reasonable efforts to accommodate the interests of other third parties when exercising the Easement Rights.
- 9. In respect of and without limiting the foregoing, Jericho agrees that when engaging in any Work, it shall use commercially reasonable efforts to ensure there is minimal interference with the traveled portion of any Road Allowances or any pedestrian, vehicular, or other traffic thereon, or any use or operation of any ditch or drain adjacent to such public right-of-way, highway, street, or walkway. Unless otherwise agreed by the County, the Road Allowances shall always be open to pedestrian, vehicular or other traffic and shall be open to the public. Without limiting the generality of the foregoing, Jericho shall be entitled to temporarily close any of the Road Allowances with the prior written consent of the County Engineer, which consent shall not be unreasonably withheld, delayed or conditioned. Jericho agrees that it shall reimburse the County for all reasonable costs associated with services rendered for traffic control purposes, and/or the erection of road closures/barriers required during the period in which Work is being performed, including but not limited to during decommissioning periods. If Jericho proposes the temporary closure of a Road Allowance, it shall also provide written notice to the Appropriate Emergency Service Providers.

#### **Right of Entry**

10. The County reserves its right to enter upon and use the Road Allowances without notice to Jericho for its own purposes and to grant and transfer rights to third parties to enter

upon and use the Road Allowances to construct, operate, maintain, alter, repair or relate infrastructure, and to modify the Road Allowances, provided such entry, use, grant or transfer by the County does not adversely affect the Transmission Infrastructure, the Work, the Wind Project or the exercise of Jericho's rights under this Agreement.

#### Title

- 11. The County represents that:
  - (a) it has legal and beneficial title to the Road Allowances;
  - (b) it has obtained the full and unconditional due authorization for execution and delivery of this Agreement by all required resolutions and other required municipal approvals;
  - (c) it shall defend its title to the Road Allowances against any person or entity claiming any interest adverse to the County in the Road Allowances during the Term of this Agreement, save and except where such adverse interest arises as a result of the gross negligence or willful misconduct of Jericho or any person for which they are responsible at law;
  - (d) the Permits are the only permits, approvals, consents or authority within the jurisdiction of the County required in connection with the Work and the fees as set forth in <u>Schedule "D"</u> attached hereto are the only fees payable by Jericho in connection with the Permits; and
  - (e) the execution and delivery of this Agreement by the County will not result in a breach of any other agreement to which the County is a party and no rights, interests or privileges have been granted in respect of the Road Allowances by the County which will or could adversely affect the rights, interests or privileges granted to Jericho hereunder.

#### Transmission Infrastructure at Expense of Jericho

12. Notwithstanding and without limiting any other term hereof, Jericho agrees and undertakes that all Transmission Infrastructure over, along, across, within or under the Road Allowances will be placed, installed, constructed, re-constructed, inspected, maintained, operated, altered, enlarged, repaired, replaced, relocated and removed at its own expense and in accordance with good engineering practices, and in compliance with Approved Road Use Plans, this Agreement and Applicable Law.

#### C. <u>ADDITIONAL TERMS AND CONDITIONS RE EASEMENT RIGHTS</u>

#### **Road Closure**

13. The County agrees, in the event of closing of any Road Allowances, to give Jericho reasonable notice of such closing and to provide Jericho with a further easement over that part of the closed Road Allowances, sufficient to allow Jericho to preserve any part of the

Transmission Infrastructure in its then existing location, and to enter upon the closed Road Allowances to maintain and repair such part of the Transmission Infrastructure.

#### Traffic Effects

- 14. Notwithstanding and without limiting any other term hereof, the Parties acknowledge that the Work from time to time may require the temporary modification of traffic patterns or the imposition of temporary restrictions on public access to or use of the Road Allowances ("**Traffic Effects**"). In the event that Jericho determine that Traffic Effects are required, Jericho agrees to:
  - (a) give five (5) days' notice of anticipated Traffic Effects to the County Engineer and affected residents and to coordinate with the County Engineer and the Appropriate Emergency Service Providers to minimize and mitigate any adverse impacts of the Traffic Effects and to ensure public safety; and
  - (b) use reasonable efforts to maintain adequate public access to and use of the Road Allowances while Traffic Effects are in progress and to remove the Traffic Effects as soon as reasonably possible when the Traffic Effects are no longer necessary.

#### Restoration

15. Jericho further agrees that in the event that it becomes necessary to break, remove, or otherwise pierce the existing surface of any of the Road Allowances or any other municipal lands to undertake any placing, installing, constructing, re-constructing, inspecting, maintaining, operating, altering, enlarging, repairing, replacing, relocating and removing Transmission Infrastructure or to undertake any Work over, along, across, within or under the Road Allowances, Jericho in all cases will repair, reinstate and restore such surface at its own expense to the same or better condition which existed prior to the performing of the Work. Jericho also agrees that, except in those cases where breaking, removing or otherwise piercing the untraveled portion of the Road Allowance forms part of the Work, it shall thereafter, for a period of twelve (12) months following the Commercial Operation Date (the "Interim Period"), monitor that portion of such restored Road Allowances, at the sole expense of Jericho, and repair any settling thereof directly caused by the placing, installing, constructing, re-constructing, inspecting, maintaining, operating, altering, enlarging, repairing, replacing, relocating and removing Transmission Infrastructure or any of the Work performed over, along, across, within or under the Road Allowances to the satisfaction of the County Engineer, acting reasonably.

#### Repairs

16. Jericho shall be liable for any and all Repair Work required to be performed on the Transmission Infrastructure or on the Road Allowances due to the existence of the Transmission Infrastructure. Any Repair Work undertaken shall restore the road surface to at least the same condition it was in immediately prior to the use of the Road Allowances by Jericho. In the event that Repair Work is required, Jericho agrees to provide the County with at least five (5) days' notice that the Repair Work will occur if such Repair Work:

- (a) will have or is likely to have Traffic Effects;
- (b) will involve or is likely to involve Tree Work;
- (c) could present a danger to public health and safety; or
- (d) is located in Entrances.
- 17. Subject to the provisions of this Agreement and provided that Repair Work on Transmission Infrastructure complies with this Agreement, Jericho shall be entitled to conduct Repair Work on Transmission Infrastructure without prior approval of the County Engineer.

#### Emergency

- 18. Notwithstanding any other provision of this Agreement, in the event of any emergency involving the Transmission Infrastructure, Jericho shall notify the Appropriate Emergency Service Providers immediately upon becoming aware of the situation and shall do all that is necessary and desirable to control the emergency, including such work in and to the Transmission Infrastructure or the Road Allowances as may be required for the purpose. If after reasonable and unsuccessful efforts to communicate with the County and in the event the emergency, at Jericho's sole determination, Jericho requires immediate access to Transmission Infrastructure, Jericho may enter upon the subject Road Allowances and/or municipal lands without prior notice to the County in order to gain access to such Transmission Infrastructure in order to address such emergency and, in so doing, shall undertake to rectify the Transmission Infrastructure to the standards and as are otherwise required by the terms of this Agreement and to thereafter provide written notification and details and specification of such Repair Work to the County on the next Business Day and to thereafter file amended Plans and drawings detailing such repairs as is otherwise required by this Agreement. Without limiting the foregoing, subject to resolving to the emergency, Jericho agrees that all work completed under this subsection shall maintain the same location of the Transmission Infrastructure as previously approved by the County.
- 19. Jericho shall be responsible for all costs associated with such emergencies. The Parties hereby agree to cooperate with each other and with the Appropriate Emergency Service Providers and Hydro One Networks Inc. to develop and adopt protocols applicable in the event of an emergency involving the Transmission Infrastructure.

#### **Upgrades Required**

20. In the event that the standard, condition or maintenance of any of the Road Allowances is not sufficient to permit Jericho to carry out its desired operations, Jericho shall be solely responsible for carrying out any work or maintenance required to upgrade the Road Allowances, at its own expense.

#### **Locating Infrastructure:**

- 21. Jericho agrees at its sole expense to:
  - (a) mark the location of Transmission Infrastructure installed by Jericho within the Road Allowances with appropriate markings;
  - (b) participate in the "Ontario One Call" system to facilitate ongoing notice to the public of the location of the Transmission Infrastructure; and
  - (c) upon written request of the County, Jericho shall properly and accurately identify the location of any Transmission Infrastructure within the County, and provide such reports to identify the depth of the relevant portion of the Transmission Infrastructure, such request to be made in writing to Jericho with advance notice of twenty (20) days prior to the County or a third party commencing work that may conflict with the Transmission Infrastructure.

#### **Relocation of Installed Infrastructure**

#### Upon Election of Jericho

22. In the event that Jericho wishes to relocate Transmission Infrastructure which has been previously installed in accordance with this Agreement at 100% its own expense, Jericho shall notify the County of such request, in writing, and such request will thereafter be considered and administered by the County acting reasonably and with diligence giving due consideration to the scope of the works already undertaken by Jericho on the Road Allowances, provided that, in considering and administering such request the County shall be entitled to take into consideration any specific municipal or engineering interests affected by such relocation including any additional facilities located within the Road Allowances. Notwithstanding the foregoing, the County shall not be permitted to unreasonably withhold, delay or condition its approval for such request.

#### Required by the County

- 23. In the event that the County, in conjunction with an approved municipal plan, and acting reasonably, deems it necessary for the location of the Transmission Infrastructure or Entrances (hereafter, "a **General Relocation**") to be taken up, removed, or modified within the Road Allowances, the General Relocation and any related installation work shall be conducted at the 100% of the expense of Jericho within a reasonable period of time and subject to Force Majeure.
- 24. Without limiting and in addition to Section 23, in the event that Jericho determines that leave to construct or amendment thereto or any other approval is required from a Public Authority, or any successor thereof, with respect to the proposed General Relocation or related installation work, then the County shall provide such reasonable period of time as is necessary for Jericho to obtain such leave to construct, amendment or other approval before closing or disposing of the Road Allowance, if applicable; provided, however, in the event that any Public Authority's approval is not provided to Jericho, both Jericho

and the County shall be bound to comply with the determination of the Public Authority and shall modify or discontinue the relocation of the Transmission Infrastructure or Entrances as necessary.

#### Required by Legislation or Lawful Order

25. In the event that a General Relocation is required as a result of the County's compliance with a legislative requirement, Ministerial order or such other law or order of a body which has the ability to force the County to act then the costs of the General Relocation and/or related installation work associated with the installed Transmission Infrastructure shall be performed by Jericho at 100% its cost.

#### By Third Party

26. Where the General Relocation under Section 24 is required due to the County accommodating a third party (hereinafter "**Third Party Work**"), the required General Relocation or related installation work shall be conducted by Jericho in accordance with the terms of this Agreement respecting installation, and the full cost of the amendment or General Relocation shall be borne solely by the third party and paid in advance. The County agrees to provide Jericho with ninety (90) days' notice of the need for any such Third Party Work and to require that the relevant third party or parties bear the full cost of such Third Party Work and indemnify Jericho against all claims and liabilities arising from the amendment or General Relocation.

#### Temporary Reconstruction or Realignment of Road Allowances

- 27. Jericho shall, upon reasonable prior notice to the County, have the right to:
  - (a) temporarily reconstruct or realign certain portions of the Road Allowances in order to permit the delivery or movement of oversized Wind Project components, including wind turbine blades, tower sections and nacelles; and
  - (b) connect access roads located on private land and running from the Wind Project turbines to the Road Allowances to permit ongoing access to such wind turbines during the period of commercial operation of the Wind Project.

#### D. <u>MAINTENANCE, SNOW CLEARANCE AND TREE WORK/REPLACEMENT</u>

#### No County Winter Maintenance

28. Jericho acknowledges that certain of the Road Allowances, which are clearly identified in the Approved Road-Use Plans (<u>Schedule "B"</u>) are not maintained by the County for winter use due to soft surfaces and otherwise. In the event that Jericho requires the Road Allowances to be maintained for winter access, they shall undertake the necessary snow plowing on its own accord and at its expense and shall be responsible for all costs associated with the repair of any Road Allowance damaged as a result of such use by Jericho.

#### **Tree Work**

29. Notwithstanding applicable statutory rights, in the event that Jericho deems it necessary to perform any Tree Work, Jericho shall be entitled to conduct the Tree Work. In the event that trees are removed from within the Road Allowances, Jericho agrees at its sole expense, to remove the tree stump to a level below grade and to restore and remediate the surface of the Road Allowance.

#### E. <u>IMPLEMENTATION OF PLANS</u>

30. Intentionally Deleted

#### **Revisions Required**

31. In the event that physical features of the Road Allowances or other obstacles or circumstances frustrate the ability of Jericho to complete the placement, installation, construction, re-construction, inspection, maintenance, operation, alteration, enlargement, repair, replacement, relocation and removal of Transmission Infrastructure in compliance in all material respects with the Approved Road Use Plans, Jericho agrees to revise the relevant Plans and submit such revised Plans for review by the County Engineer. If a material revision is required, subject to Section 64 of this Agreement, the County agrees to expedite in the instance of a revision of Plans submitted and agrees not to unreasonably condition, delay or withhold approval of revised Plans.

#### Adherence to Approved Road Use Plans

32. Jericho further agrees to commence, perform and complete the placement, installation, construction, re-construction, inspection, maintenance, operation, alteration, enlarging, repairing, replacing, relocating and removing Transmission Infrastructure in compliance with the Approved Road Use Plans within a reasonable margin of error.

#### Filing of As-Built Plan Following Installation etc.

33. Following the completed placement, installation, construction, re-construction, inspection, maintenance, operation, alteration, enlarging, repairing, replacing, relocating and removing Transmission Infrastructure and within one hundred eight (180) days after the Commercial Operation Date, Jericho agree to conduct the necessary investigation necessary to produce and file with the County Engineer an As-Built Plan together with a final electronic copy (CD ROM or DVD) prepared in an AUTOCAD, CAD or GIS environment of the As-Built Plan, showing the exact location and specifications of any Transmission Infrastructure installed over, along, across, under or within the Road Allowances and any Entrances. The Parties agree that the County shall not release of any deposits or securities held until the As-Built Plan is filed.

#### **Post-Installation Report and Required Repairs**

34. Following the County Engineer's receipt of notice from Jericho confirming that installation of the placement, installation, construction, re-construction, inspection,

maintenance, operation, alteration, enlarging, repairing, replacing, relocating and removing Transmission Infrastructure over, along, across, within or under the Road Allowances is complete (the "**Completion Notice**"), the County Engineer shall conduct a further inspection and provide a post-installation report (the "**Post-Installation Report**"), which includes the following:

- (a) identification of the Road Allowances which in the opinion of the County Engineer, have been damaged or destroyed by Jericho and its employees, agents or contractors during the placement, installation, construction, re-construction, inspection, maintenance, operation, alteration, enlarging, repairing, replacing, relocating and removing Transmission Infrastructure over, along, across, within or under the Road Allowances, hauling, or establishing of Entrances; and
- (b) identification of the repairs, replacements or remedial work necessary to repair the damaged Road Allowances.

The County Engineer's inspection, for the purposes of producing the Post-Installation Report shall be completed no later than ten (10) business days following receipt by the County of the Completion Notice. Jericho agree to repair any and all damage to the Road Allowances directly caused by the Work in accordance with the Post-Installation Report (hereinafter referred to as the "**Required Repairs**"). In the event Jericho fails to complete the Required Repairs in a manner and within a timeframe acceptable to the County Engineer acting reasonably, the County may do so at the sole expense of Jericho.

#### **Final Condition Report and Final Repairs**

35. Following the expiry of the Interim Period, the County's Engineer shall forthwith conduct an inspection of the Road Allowances to either (i) confirm its satisfaction that all restoration work has been completed and that the Road Allowances are in the same or better condition which existed prior to the performing of the Work; or (ii) identify those Road Allowances which are not in the same or better condition which existed prior to the performing of the Work and identify the repair, replacement or remedial work required to repair the Road Allowances to the same condition which existed prior to the performing of the Work (the "Final Condition Report"). The County Engineer's inspection, for the purposes of producing the Final Condition Report shall be completed no later than ten (10) Business Days following the expiry of the Interim Period and the Final Condition Report shall be delivered to Jericho not later than ten (10) Business Days following the date of inspection aforesaid. Jericho agrees to repair any damage to the Road Allowances identified in the Final Condition Report (the "Final Repairs") within a reasonable period of time. In the event Jericho fails to complete the Final Repairs in a manner and within a timeframe acceptable to the County Engineer acting reasonably, the County may do so at the sole expense of Jericho.

#### F. <u>COMPENSATION</u>

#### For Use of Road Allowances

- 36. To offset the administrative expenses incurred by the County as a result of the use of its Road Allowances and to further secure covenants of Jericho as set out in this Agreement, Jericho agrees to pay to the County,
  - (a) An initial payment of ten thousand dollars (\$10,000.00) within 30 days of the Effective Date of this Agreement, which shall *inter alia*, fully compensate the County for all reasonable out of pocket costs incurred in connection with the preparation and implementation of this Agreement including reasonable legal, engineering and inspection costs; and

An annual fee in the amount of four thousand dollars (\$4,000.00) per kilometer of transmission lines located on County Road Allowances per year, payable by March 31 of every year during the Term of this Agreement.

- (b) The appropriate permit fees, which fees are shown in the Permits and Fees Document (<u>Schedule "D"</u>) with respect to those permits Jericho requires in order to engage in desired actions while using the rights identified in this Agreement.
- 37. All overdue payments payable by Jericho to the County under the terms of this Agreement shall bear interest at the rate of ten (10%) per cent per annum.

#### **First Security Deposit**

38. Prior to the commencement of the Work, Jericho shall deposit with the County an irrevocable letter of credit in a form satisfactory to the County and from a financial institution satisfactory to the County, acting reasonably (the "**First LC**") in the amount of \$250,000, which shall secure the obligations of Jericho pursuant to this Agreement during the initial placement, installation and construction of the Transmission Infrastructure over, along, across, within or under the Road Allowances. Jericho acknowledges and agrees that the County shall be entitled to draw on and use the proceeds from the First LC to complete the Required Repairs if Jericho fails to do so in accordance with Section 34 of this Agreement.

#### Second Security Deposit

39. Following the completion of any Required Repairs to the satisfaction of the County acting reasonably, the County shall forthwith return the First LC to Jericho and Jericho shall, within five (5) business days of the receipt of the First LC, provide a second irrevocable letter of credit in a form satisfactory to the County and from a financial institution satisfactory to the County, acting reasonably (the "Second LC") in the amount of \$125,000, which shall secure the obligations of Jericho with respect to Section 35. Jericho acknowledges and agrees that the County shall be entitled to draw on and use the proceeds of the Second LC to complete the Final Repairs in the event Jericho fails to do so within a reasonable period of time, in accordance with Section 35 of this Agreement.

The County shall return the Second LC to Jericho within five (5) business days following the earlier of, (i) the date on which Jericho notifies the County that the Final Repairs required to be performed by Jericho pursuant to Section 35 have been satisfactorily completed in the opinion of the County, acting reasonably; and (ii) the date which is ninety (90) days following the date of the Final Condition Report.

#### **G: LIABILITY**

#### **Risk with Jericho**

40. Jericho hereby acknowledges that the placement, installation, construction, reconstruction, inspection, maintenance, operation, alteration, enlarging, repair, replacement, relocation and/or removal of any Transmission Infrastructure by Jericho in accordance with the Easement Rights granted hereunder is performed entirely at the risk of Jericho and that the County shall in no way or under any circumstances will be responsible or liable to Jericho or its contractors, agents, or customers for any damage or losses in consequence thereof, unless due to the negligent or intentional acts of the County or those for whom it is at law responsible.

#### Indemnification

41. Jericho will indemnify and hold harmless the County, its Warden, Councilors, officers, employees, legal counsel, agents and contractors from and against any and all claims, suits, demands, liabilities, losses, costs, damages, and other expenses of every kind that the County may incur or suffer as a direct consequence of the Easement Rights granted hereunder, except where such claims, suits, demands, liabilities, losses, costs, damages, and other expenses costs, damages, and other expenses result from the negligence or intentional acts of the County, its Warden, Councilors, officers, employees, legal counsel, agents or contractors.

#### No Joint Venture, Partnership or Co-ownership

42. The Parties hereby acknowledge and agree that this Agreement is solely a road use agreement and that no relationship is formed between the Parties in the nature of a joint venture, partnership co-ownership arrangement or other similar relationship.

#### G. <u>ABANDONMENT AND DECOMMISSIONING OF TRANSMISSION</u> INFRASTRUCTURE

#### Notice of Abandonment

43. During the Term of this Agreement, Jericho may elect to permanently discontinue the use of (hereinafter, "**Abandon**") any part of the Transmission Infrastructure in which event Jericho shall provide written notice specifying the part of the Transmission Infrastructure to be abandoned and the date when the abandonment will occur.

#### Removal

44. If Jericho Abandons any part or all of the Transmission Infrastructure, it shall decommission and remove in accordance with the Wind Project's decommissioning plan and the Ministry of Environment ("MOE") requirements in Jericho's Renewable Energy Approval ("REA"). Should Jericho fail to decommission and remove the infrastructure as set out above, the County may, to the extent permitted by Applicable Law, retain necessary personnel to remove the infrastructure and Jericho shall compensate the County for 100% of its cost to decommission and remove the infrastructure. This provision shall survive the termination of this Agreement.

#### H. <u>DEFAULT</u>

#### Breach

45. Subject to the rights granted to any Secured Parties hereunder or by the County, in the event that a Party commits a material breach of or omits to comply with any of the provisions of this Agreement (the "**Defaulting Party**") which continues for at least sixty (60) days after written notification of such default is provided to the Defaulting Party, the other Party (the "**Complainant**") shall have the right to terminate this Agreement. However, if the Defaulting Party shall have remedied the breach or shall have commenced to remedy the breach and has diligently pursued the remedying thereof within the sixty (60) days after the initial written notification of default, the Defaulting Party shall be allowed not less than one hundred and fifty (150) days after the expiry of the original notice period to remedy the breach, or such longer period of time as is reasonable in the circumstances. In the event of default by Jericho and without such default being rectified within the time period referred to in this section, the County shall have the right to terminate this Agreement

#### **Expiration of PPA**

46. Notwithstanding any other term or provision of this Agreement, if the PPA expires or is terminated and not otherwise extended or renewed during the Term of this Agreement, and Jericho does not secure an adequate replacement market for the electricity generated by the Wind Project within ninety (90) days of the expiry or termination of the PPA, this Agreement shall, at the option of Jericho be terminated.

#### **Force Majeure**

- 47. Whenever, and to the extent that a Party will be unable to fulfill or will be delayed or restricted in the fulfillment of any obligations under any provision of this Agreement by reason of:
  - (a) strikes;
  - (b) lock-outs;

- (c) war acts of military authority;
- (d) rebellion or civil unrest;
- (e) material or labour shortage not within the control of the affected Party;
- (f) fire or explosion;
- (g) inclement weather, flood, wind, water, earthquake, or other casualty;
- (h) changes in Applicable Law not wholly or mainly within the control of the affected Party, including the revocation by any Public Authority of any permit, privilege, right, approval, license or similar permission granted to Jericho or the Wind Project;
- (i) any event or matter not wholly or mainly within the control of the affected Party (other than lack of funds or any financial condition of the parties hereto); or,
- (j) acts of God,

(in each case a "**Force Majeure**") not caused by the default or act of or omission by that Party and not avoidable by the exercise or reasonable effort or foresight by it, then, so long as any such impediment exists, that Party will be relieved from the fulfillment of such obligation and the other Party will not be entitled to compensation for any damage, inconvenience, nuisance or discomfort thereby occasioned. The Party relying on Force Majeure will be required and is entitled to perform such obligation within a period of title immediately following the discontinuance of such impediment that is equal to the period of time that such impediment existed. A Party shall promptly notify the other Party of the occurrence of any Force Majeure, which might prevent or delay, that doing or performance of acts or things required to be done or performed.

#### I. <u>MISCELLANEOUS</u>

#### Assignment

- 48. Subject to the provisions in other paragraphs of this Agreement, Jericho shall not assign this Agreement without the written consent of the County, which shall not be unreasonably withheld, delayed or conditioned, except that no consent shall be required for Jericho to assign this Agreement to an affiliated or successor entity, or for purposes of securing indebtedness or other obligations respecting the Transmission Infrastructure or the Wind Project. The County acknowledges that a change in control of Jericho shall not be considered an assignment by Jericho of this Agreement or of any of Jericho's rights and obligations under this Agreement.
- 49. Jericho shall be entitled to assign this Agreement and all of its rights thereunder without the consent of the County to the Secured Parties as security for Jericho's obligations to such Secured Parties which shall be further entitled to assign this Agreement and Jericho's rights thereunder in connection with an enforcement of their security. The

County hereby grants to any Secured Party the rights and remedies set forth in this Agreement, including those rights and remedies set forth in <u>Schedule "E"</u>. In addition, the County will, from time to time, at the request of the Secured Party, promptly execute and deliver in favour of any Secured Party such consents and acknowledgements granting and confirming the rights and remedies in this Agreement, including those rights and remedies set forth in <u>Schedule "E"</u>. The County shall enter into any other reasonable agreements with the Secured Party, as may reasonably be required by Jericho in order to obtain financing from the Secured Party.

- 50. Jericho shall be entitled, with the written consent of the County, which may not be unreasonably conditioned, delayed, or withheld, to assign this Agreement to a transferee of the Wind Project other than an affiliated or successor company, and Jericho shall thereupon be released from any and all obligations under this Agreement from and after the date of such assignment, provided that such assignee has agreed in writing with the County, in a form acceptable to the assignee and the County, both acting reasonably, to be bound by the provisions of this Agreement from and after the date of the assignment.
- 51. In the event Jericho applies to the County for consent to a transfer, the County shall have a period of thirty (30) days following receipt of sufficient information to make a determination as to whether the County shall provide or refuse to provide its consent to the proposed transfer. The County's failure to respond within that thirty (30) day period shall be construed as consent by the County.
- 52. Any documents relating to a transfer or the County's consent will be prepared by the County or its solicitors or their retained agents and all of the legal costs borne as a result by the County together with a reasonable administrative charge of One Thousand Dollars (\$1,000) shall be reimbursed to the County by Jericho on demand.

#### **Dispute Resolution**

- 53. In the event that either Party provides the other Party with written notice of dispute regarding the interpretation or implementation of this Agreement (a "**Dispute**") then both Parties shall use their best efforts to settle the Dispute by consulting and negotiating with each other in good faith to reach a solution satisfactory to both Parties. However, if the Parties do not resolve the Dispute within thirty (30) days following receipt of such notice, then either Party may provide written notice to the other Party (the "**Arbitration Notice**") requiring resolution by arbitration or thereafter the Dispute shall be referred to arbitration in accordance with the provisions of the *Arbitration Act*, 1991.
- 54. The Parties agree to the following with respect to any arbitration between the Parties:
  - (a) the arbitration tribunal shall consist of on arbitrator appointed by mutual agreement of the Parties or, if the Parties fail to agree on an arbitrator within ten (10) days after receipt of the Arbitration Notice then either Party may apply to a judge of the Ontario Superior Court of Justice to appoint an arbitrator;
  - (b) The arbitrator shall be qualified by education and training to be able to decide upon the matter to be decided;

- (c) The arbitration shall be conducted in English;
- (d) The arbitration shall take place in the geographic boundary of the County of Middlesex or another place mutually agreed upon by the Parties;
- (e) The arbitration award shall be given in writing and shall address the question of costs of the arbitration and all related matters;
- (f) The arbitration award shall be final and binding on the Parties as to all questions of fact and shall be subject to appeal only with respect to matters of law or jurisdiction.
- 55. The Parties agree that except to the extent that a matter is specifically the subject of a Dispute, both Parties shall continue to observe and perform the terms and conditions of this Agreement pending the resolution of a Dispute.

#### **Termination by Jericho**

56. Jericho may upon six (6) months' notice in writing, terminate this Agreement. Once the notice has been provided, Jericho shall be liable to the County for the provisions of this Agreement to the date of termination. Following the termination date, Jericho will only be liable for the provisions which survive this Agreement.

#### **Further Assurances**

57. Each of the Parties covenant and agrees with the other that it will at all times hereafter execute and deliver, at the request of the other, all such further documents, agreements, deeds and instruments, and will do and perform all such acts as may be necessary to give full effect to the intent and meaning of this Agreement.

#### Notices

58. The parties hereto agree as follows:

Any written notice provided for and contemplated by this Agreement will be delivered to the parties by hand or registered mail at the following addresses:

To the County:	The Corporation of the County of Middlesex Attention: County Clerk 399 Ridout Street North London, ON N6A 2G7
To Jericho:	Jericho Wind, Inc. Attention: Business Management 390 Bay Street, Suite 1720 Toronto, ON, M5H 2Y2, Canada
	Phone: (416) 364-9714

Jericho Wind, Inc.
Attention: General Counsel
700 Universe Blvd. LAW/JB
Juno Beach, Florida 33408
Phone: (561) 691-2359

Every such notice shall be deemed to have been received if personally delivered at the time of such delivery and if sent by prepaid registered mail, at the end of five (5) business days after the mailing thereof.

#### **Governing Law**

59. This Agreement shall be governed by, and be construed and interpreted in accordance with, the laws of Ontario and the laws of Canada applicable in Ontario.

#### Counterparts

60. This Agreement may be executed by facsimile or PDF transmission and in one or more counterparts, all of which shall be considered one and the same Agreement.

#### **Binding Covenant**

61. This Agreement and the rights granted hereunder are and shall be of the same force and effect, to all intents and purposes, as a covenant running with the Road Allowances. The provisions of this Agreement, including all of the covenants and conditions herein shall extend, be binding upon and enure to the benefit of the County, Jericho and their respective successors and permitted assigns as the case may be.

#### Severability

62. The invalidity or unenforceability of any provision of covenant contained in this Agreement shall affect the validity or enforceability of such provision or covenant only and any such invalid provision or covenant shall be deemed to be severable from the balance of this Agreement, which shall be enforced to the greatest extent permitted by law.

#### Amendments to the Agreement

63. No supplement, modification, amendment, or waiver of this Agreement shall be binding unless executed in writing by the Parties.

#### Amendments to the Approved Road Use Plans

64. Any material amendment to the Approved Road Use Plans will be submitted to the County Engineer for his approval, who will not unreasonably withhold such approval. The Parties agree that once approved, the amended Approved Road Use Plans shall substitute for, and replace the attached <u>Schedule "B"</u> as part of this Agreement.

#### Waiver

65. No supplement, modification, amendment, or waiver of this Agreement shall be binding unless executed in writing by the Parties.

#### **Foreign Corrupt Practices Act and Anti-Bribery Indemnity**

66. Notwithstanding anything to the contrary herein, the County, in its administration of this Agreement, shall refrain from offering, giving or promising, directly or indirectly, money or anything of value to a Canadian or foreign governmental official to influence the official in his or her official capacity, induce the official to do or omit to do an act in violation of his or her lawful duty, or to secure any improper advantage in order to assist in obtaining or retaining business for or with, or directing business to, any person. For the purposes of this Section, "anything of value" includes, but is not limited to, cash or a cash equivalent, discounts, gifts, use of materials, facilities or equipment, entertainment, drinks, meals, transportation, lodging, insurance benefits, or promise of future employment. "governmental official" shall mean any person holding any level of legislative, administrative, or judicial office of the Canadian or a foreign government or any of its departments or agencies or divisions; any person acting on behalf of the Canadian or a foreign government, including a local or provincial agency, enterprise, or organization; any official or agent of a Canadian or a foreign public administration or publicly funded organization; any official of a Canadian or a foreign political party; any officer or agent of a public international organization (e.g., World Bank, International Monetary Fund, World Health Organization, United Nations, World Trade Organization); or any relatives or close family/household members of any of those listed above. The County shall indemnify and hold harmless Jericho from all claims brought against Jericho as a result of the County or its representatives' failure to comply with Anti-Bribery Law. The County shall immediately report any breach of Anti-Bribery Law by the County or its representatives. The County shall indemnify and hold harmless Jericho from all claims brought against Jericho as a result of the County or its representatives' failure to comply with Anti-Bribery Law. The County shall immediately report any breach of Anti-Bribery Law by the County or its representatives. Jericho shall have the right to audit the County's books and records with respect to payments made on behalf of Jericho in the event that Jericho believes that the County has violated this Section 66. Jericho shall have the right to immediately terminate all payments to the County under this Agreement if the County fails to comply with this Section 66.

IN WITNESS WHEREOF the parties hereto affix their hands and seal or corporate seals, attested to by the hand of their authorized officers, as the case may be, at  $\underline{london}$ , Ontario, this  $\underline{l2^{44}}$  day of  $\underline{lovenba1}$ , 2013 to be effective as of the date first written above.

SIGNED, SEALED AND DELIVERED in the presence of

# THE CORPORATION OF THE COUNTY OF MIDDLESEX

Warden Clerk

We have the authority to bind the Corporation

SIGNED, SEALED AND DELIVERED in the presence of

#### JERICHO WIND INC.

Per:

Title:

I have the authority to bind the Corporation

IN WITNESS WHEREOF the parties hereto affix their hands and seal or corporate seals, attested to by the hand of their authorized officers, as the case may be, at \_\_\_\_\_\_, Ontario, this \_\_\_\_\_\_, day of \_\_\_\_\_\_, 2013 to be effective as of the date first written above.

SIGNED, SEALED AND DELIVERED in the presence of

# THE CORPORATION OF THE COUNTY OF MIDDLESEX

Warden

Clerk

We have the authority to bind the Corporation

SIGNED, SEALED AND DELIVERED in the presence of

#### JERICHO WIND INC.

Per: F. Allen Wiley Title: Vice President I have the authority to bind the Corporation

#### SCHEDULE "A"

#### Jericho Asset Document



CONFIDENTIAL

#### **SCHEDULE "B"**

Approved Road Use Plans




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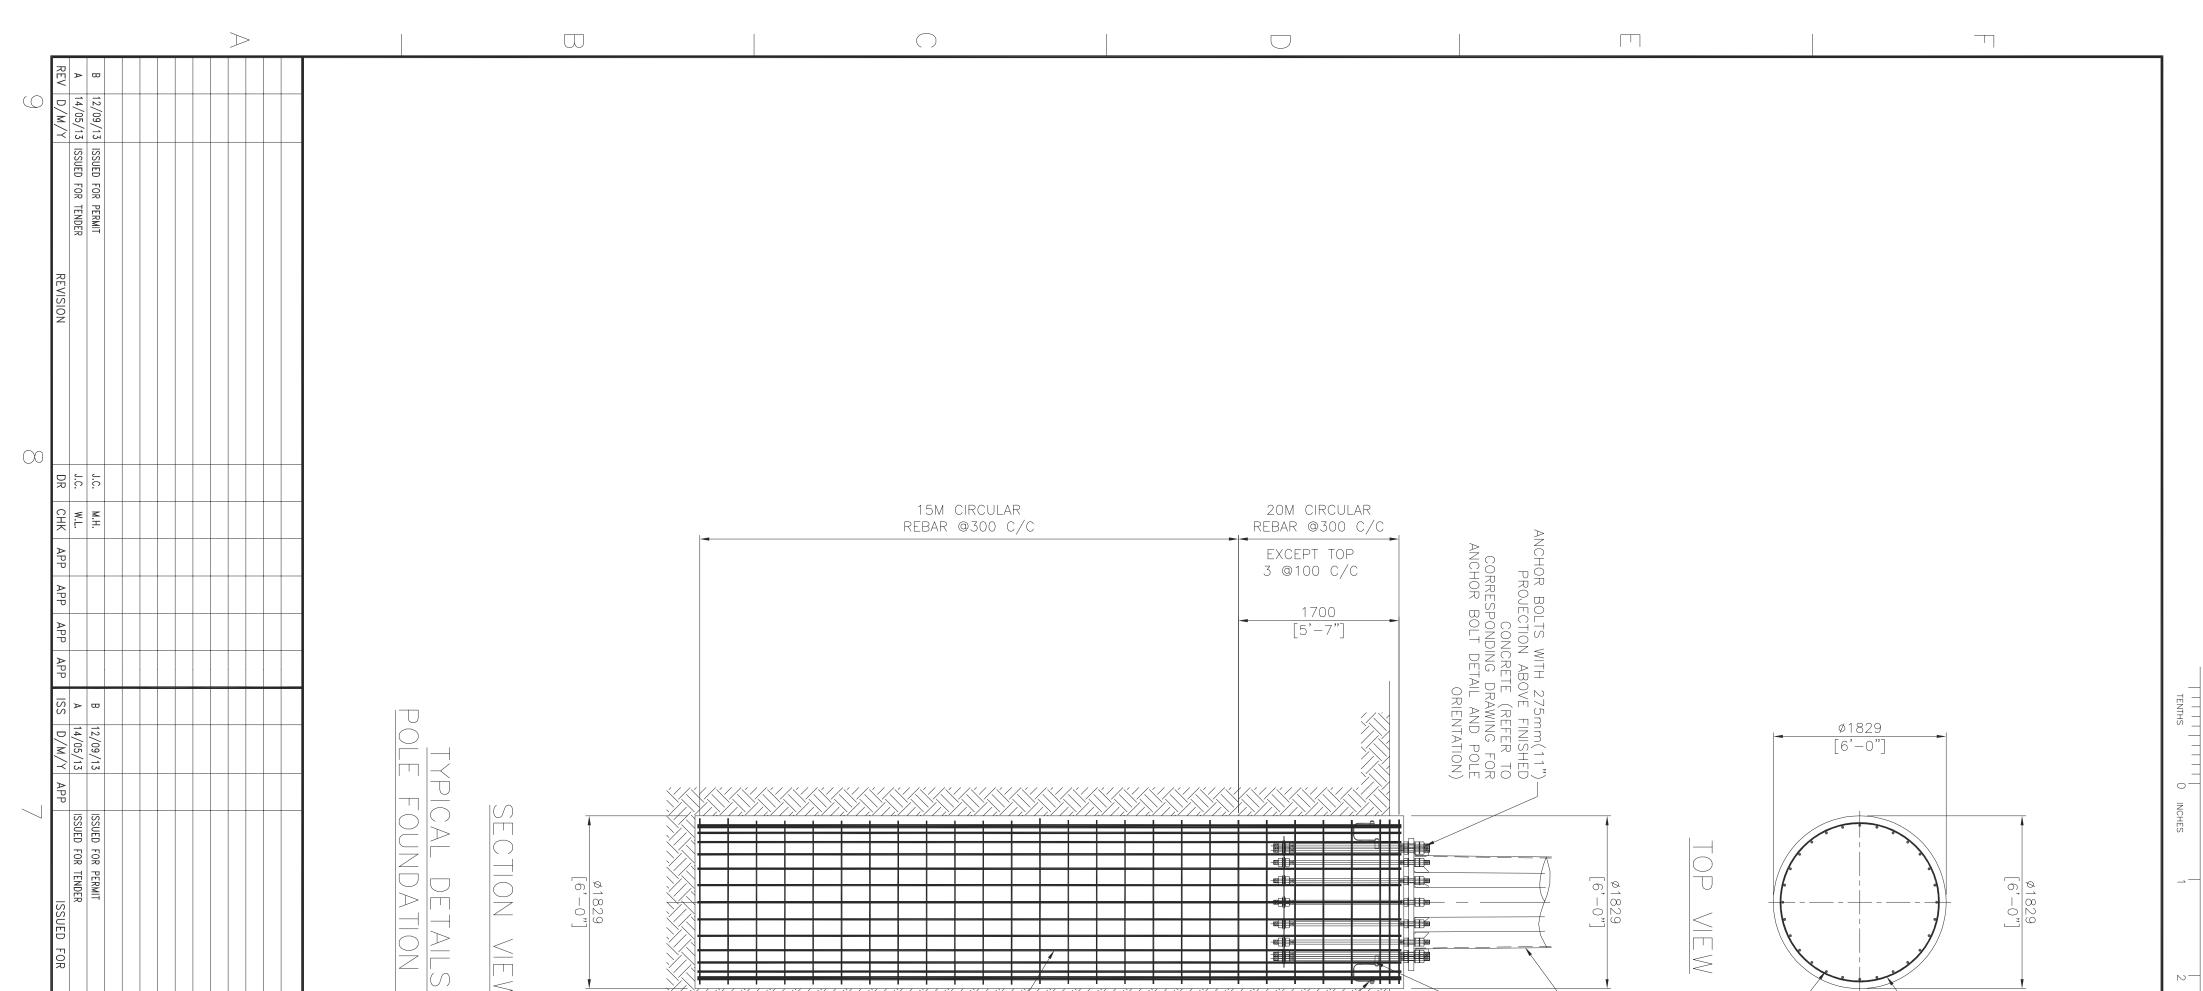
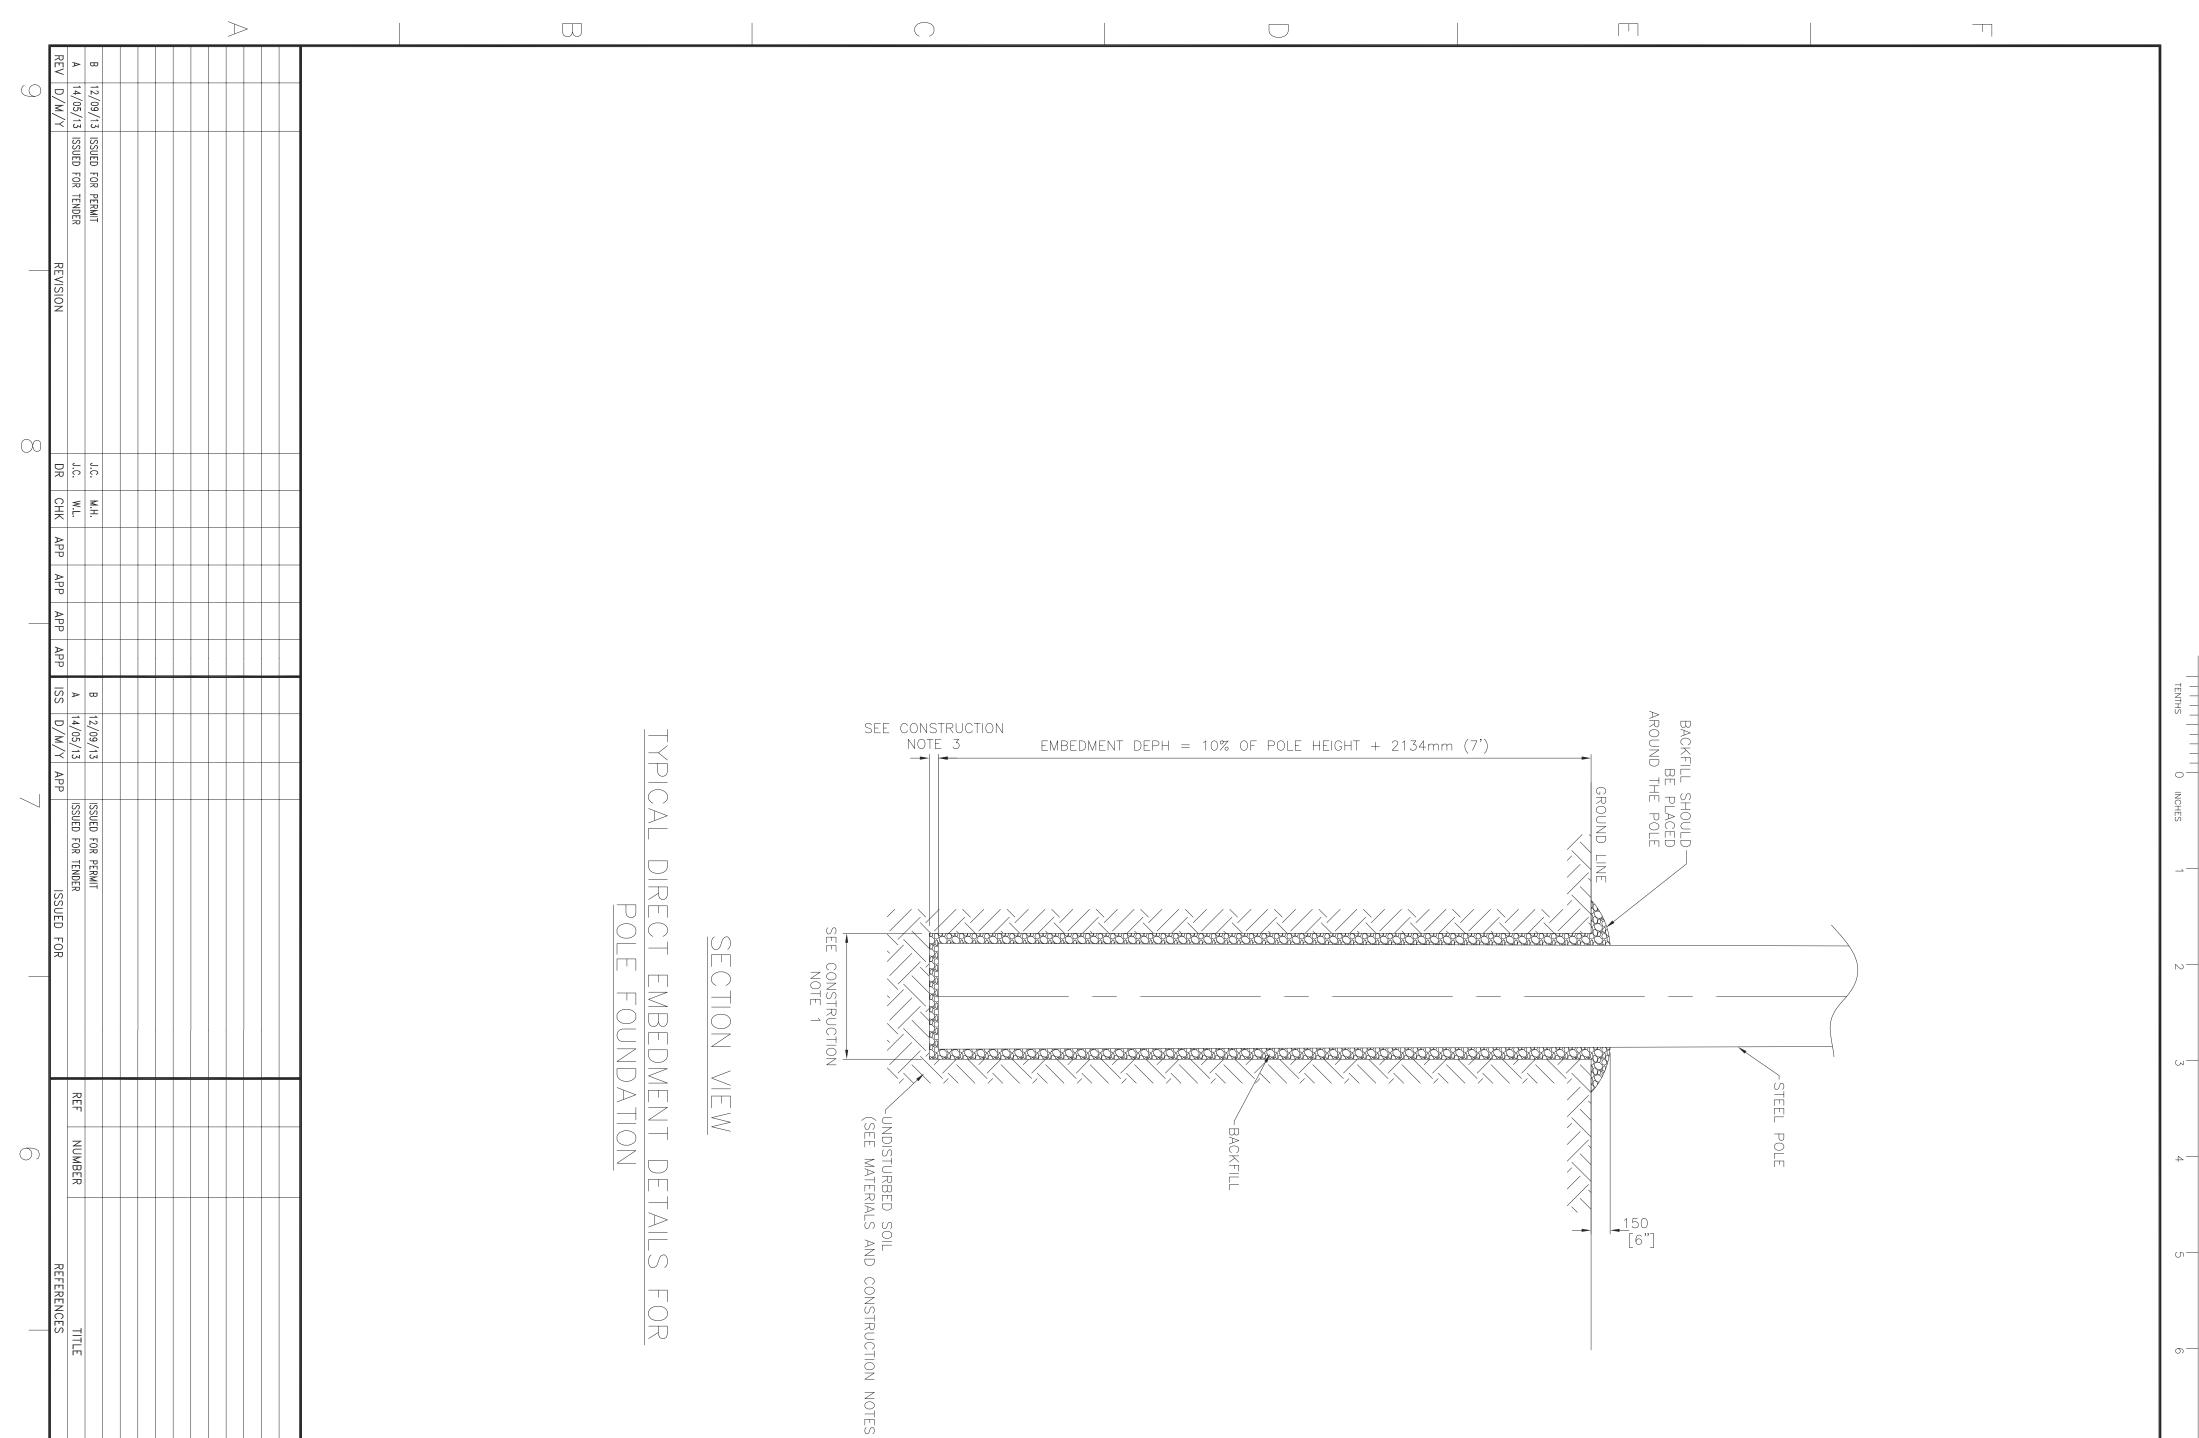


Image: Stand		<u>7500</u> [24'-7 <sup>1</sup> <sub>2</sub> "]	WPRESSION WELD FOR VERTICAL R. CU.	MPRESSION WELD FOR ANCHOR . CU.	
APPROVED FOR CONSTRUCTION           APPROVED FOR CONSTRUCTION         APPROVED FOR CONSTRUCTION         Chimax Inc.           CLIENT PROJECT MGR.         DEPARTMENT MGR.         PROJECT MGR.         Chimax Inc.           PROJECT PHASE         ACTIVITY NO.         PACKAGE CODE         AREA         JERICHO WIND PROJECT         Engineering Company Seguerering Company Seguering Company Seguerering Company Seguer	NOT FOR CONSTRUCTION DESIGN IN PROGRESS	FROPER VIBRALL BE ADEQUATELY CURED BY ADDITIONAL MOISTURE AND/OR WATER RETAINING MATERIAL AFTER POURING. ALL EXPOSED CONCRETE EDGES SHALL HAVE A 25mm CHAMFER. ALL BACKFILL SURROUNDING FOUNDATIONS SHALL BE WELL GRADED PIT RUN CONFORMS TO RECOMMENDED SPECIFICATIONS SHALL BE WELL GRANDED WITH MA GEOTECHNICAL REPORT AND SHALL BE COMPACTED TO 95% SPMDD WITH MA JOOmm. ALL BACKFILL UNDER FOUNDATIONS SHALL BE LEAN CONCRETE MIX OR GRAN MATERIAL AND SHALL BE COMPACTED TO 100% SPMDD WITH MAX LIFT OF 2 SAFETY MEASURES SHALL BE PROVIDED AFTER EXCAVATION TO ENSURE WOF SAFETY.	<ul> <li>FORMED CONCRETE SUFFACE EXPOSED TO WEATHER = 50mm</li> <li>FORMED CONCRETE SUFFACE EXPOSED TO WEATHER = 50mm</li> <li>REINFORCING STEEL SHALL BE DEFORMED STEEL BAR MTH MINIMUM YIELD STRENGTH OF</li> <li>400 MPG (60PSI) AND CONFIRMING TO CSA G30.12 GR.400 EXCEPT TIES AND STIRRUPS</li> <li>400 MPG (60PSI) AND CONFIRMING TO CSA G30.12 GR.400 EXCEPT TIES AND STIRRUPS</li> <li>5. MINIMUM SPLICES, LAPS AND HOOKS SHALL BE IN ACCORDANCE MTH CAN 3-A23.1</li> <li>6. ALL OTHER STEEL MATERIAL SHALL BE CSA-G40.21-M300W U.N.O. AND SHALL BE HOT</li> <li>7. ALL EXCAVATIONS SHALL BE PERFORMED IN A MANNER THAT SHALL ENSURE PROPER</li> <li>DRAINAGE DURING THE COURSE OF WORK. FLOODED EXCAVATIONS SHALL BE DEWATERED</li> <li>A FTER EXCAVATION, SHALL BE PERFORMED TO PROVED EFFORE PROCEEDING WTH WORK. ALL EXCAVATIONS</li> <li>SHALL BE SUFFICIENTLY SUPPORTED TO PREVENT COLLAPSE.</li> <li>A FTER EXCAVATION, EXPOSED SOIL SUFFACES SHALL BE PROTECTED PROPER</li> <li>CONSTRUCTION AND EXCAVATION METHOD BASED ON THE SOIL CONDITION FOUND ON STIEL</li> <li>SHOR TO THE PLACEMENT. TO FORMETE .BOTTOM OF FOUNDATIONS SHALL BE INSPECTED</li> <li>SEFORE PLACING CONCRETE. CONTRACTOR SHALL VERIFY ANGLOR BOLSIN PARAMETERS</li> <li>DEFORE PLACING CONCRETE. CONTRACTOR SHALL VERIFY ANGLOR BOLSIN PARAMETERS</li> <li>DEFORE PLACING CONCRETE. CONTRACTOR SHALL VERIFY ANGLOR BOLSIN PARAMETERS</li> <li>DEFORT PLACING CONCRETE. CONTRACTOR SHALL VERIFY ANGLOR BOLSIN PARAMETERS</li> <li>DEFORT PLACING CONCRETE. CONTRACTOR SHALL VERIFY ANGLOR BOLSIN PARAMETERS</li> <li>DEFORT PLACING AND VERTICAL WESTIGATION REPORT AND DESIGN PARAMETERS</li> <li>DEFORT PLACING WATTOW AND VERTICES OF VERTICES FOR EMBEDDED TEMES, HOLES, ETC.</li> </ul>	20 DEG 20 DEG FROM 1.2m TO 1.6m BELOW GRADE, AVERAGE PENETRATION INDEX 'N' = 8 (C FOR STRUCTURE B-N001 TO B-N027, AND 'N' = 5 (COHESIVE) FOR STRUCTU TO B-N082 FROM 1.6m TO 2.4m BELOW GRADE, AVERAGE PENETRATION INDEX 'N' = 10 ( FROM 2.4m BELOW GRADE, AVERAGE PENETRATION INDEX 'N' = 15 (COHESIVE) DATION MATERIAL AND CONSTRUCTION NOTES CONCRETE MATERIAL, DESIGN, TESTING AND CONSTRUCTION SHALL BE IN ACCO WITH CSA STANDARD CAN 2-A23 SERIES. CONCRETE SPECIFICATION SUPPLY AND DELIVERY OF CONCRETE SHALL BE AS FOLLOWS: MINIMUM COMPRESSIVE STRENGTH: 35 MPd AT 28 DAYS SPECIFICATIONS ON PORTLAND CEMENT: TYPE GU NORMAL PORTLAND CEMENT, CLASS C-1 4%-7% AIR CONTENT MIN. 3 CYLINDERS TESTING WITH ONE AT 7 DAYS AND TWO AT 28 DAYS ARE UNLESS OTHERWISE SPECIFIED, MINIMUM CONCRETE COVER TO REINFORCEMENT AS FOLLOWS: CONCRETE OF CONCRETE OF TO THE OF TO THE OF TO THE OF THE	GENERAL NOTES         1.       THIS DRAWING SHALL BE READ IN CONJUNCTION WITH THE PLAN AND PROFILE DRAWINGS (DWG#1235-3-PO12), ANCHOR BOLT DRAWINGS AND STAKING INFORMATION.         2.       FOR POLE FRAMING DETAILS, SEE DWG#1235-3-FO11 AND 102.         3.       FOR ANOHOR BOLT DETAILS, SEE DWG#1235-3-F101 AND 102.         4.       ALL DIMENSIONS AS SHOWN ARE METRIC IN MILLIMETERS U.N.O.         DESIGN ASSUMPTION         1.       GROUND WATER LEVEL IS DESIGNED AT GRADE.         2.       FOR TO THE INFORMATION ON BOREHOLE RECORD, THE FOLLOWING DESIGN PARAMETER         3.       AND ASSUMPTIONS ARE ADOPTED FOR THE FOULDATION DESIGN:         4.       FROM 0m TO 1.2m BELOW GRADE         3.       FROM 0m TO 1.2m BELOW GRADE, ASSUMED LOOSE CONDITION WITH FRICTION ANGLE =



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GENERAL NOTES

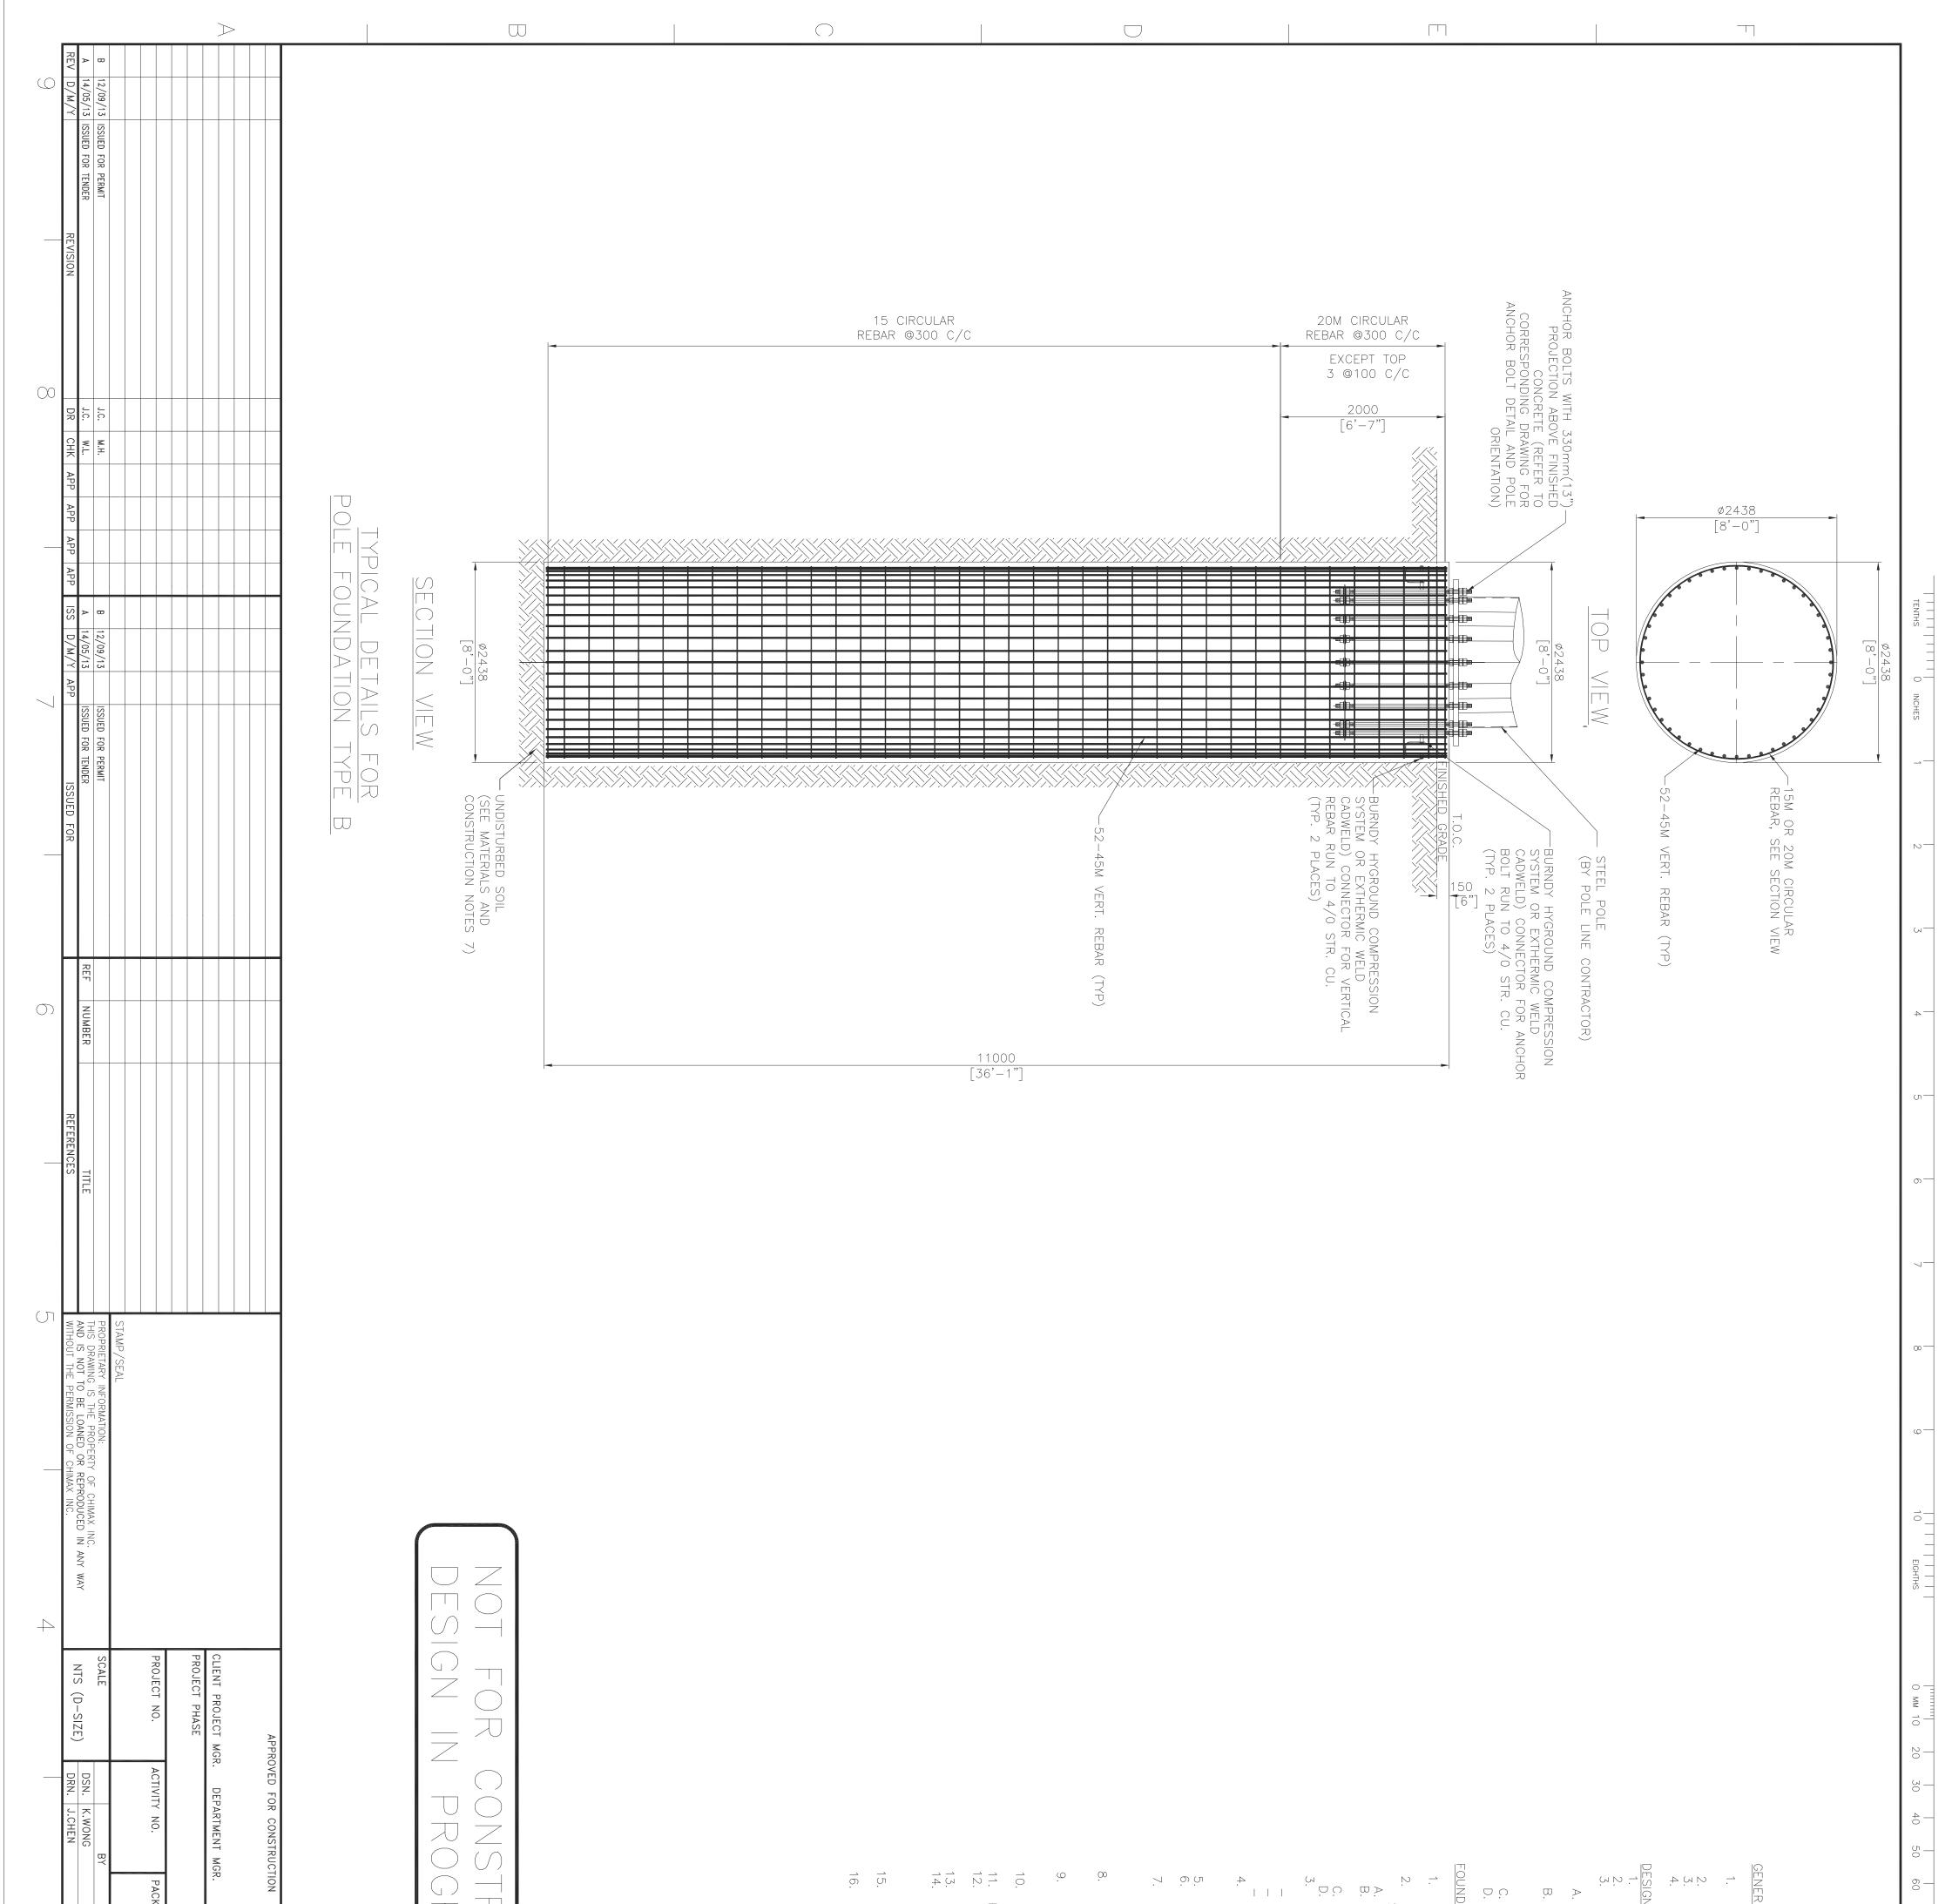- THIS DRAWING SHALL BE READ IN CONJUNCTION WITH THE PLAN AND PROFILE DRAWINGS (DWG#1235-3-P012), ANCHOR BOLT DRAWINGS AND STAKING INFORMATION.
   FOR POLE FRAMING DETAILS, SEE DWG#1235-2-P3XX SERIES
   ALL DIMENSIONS AS SHOWN ARE METRIC IN MILLIMETERS U.N.O.

# DESIGN ASSUMPTION

- GROUND WATER LEVEL IS DESIGNED AT GRADE.
   FROST DEPTH IS 1.2m (4') BELOW GRADE
   BASED ON THE INFORMATION ON BOREHOLE RECORD, THE FOLLOWING DESIGN PARAMETER AND ASSUMPTIONS ARE ADOPTED FOR THE FOUNDATION DESIGN:
   FROM 0m TO 1.2m BELOW GRADE, ASSUMED LOOSE CONDITION WITH FRICTION ANGLE = 20 DEG
   FROM 1.2m TO 1.6m BELOW GRADE, AVERAGE PENETRATION INDEX 'N' = 8 (COHESIVE) FOR STRUCTURE B-N001 TO B-N027, AND 'N' = 5 (COHESIVE) FOR STRUCTURE B-N028 TO B-N082
   FROM 1.6m TO 2.4m BELOW GRADE, AVERAGE PENETRATION INDEX 'N' = 10 (COHESIVE)
   FROM 2.4m BELOW GRADE, AVERAGE PENETRATION INDEX 'N' = 15 (COHESIVE)

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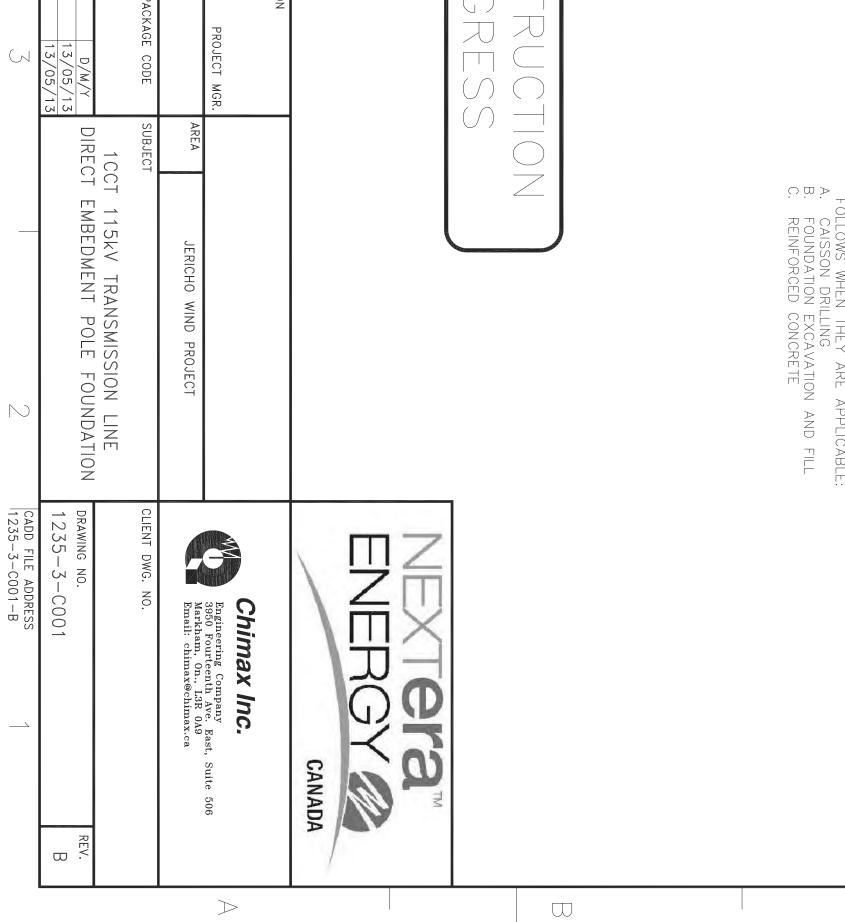
# FOUNDATION MATERIAL AND CONSTRUCTION NOTES


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- MINIUM DIAMETER OF HOLE EXCAVATION SHALL BE POLE BUTT DIAMETER + 300mm (12°)
   DEPTH OF HOLE IN SLOPING GROUND SHALL BE MEASURED FROM THE LOWER SIDE OF HOLE.
   A MINIUM OF 450mm (18°) OF CRUSH STONE OR ROCKS SHALL BE USED AND TO BACKFILL THE BOTTOM OF THE BOLE HOLE. PROPER COMPACTION OF BACKFILL MATERIAL SHALL BE LISURED. THE CONTRACTOR SHALL ENSURE THE MINIUM POLE EMBEDMENT DEPTH IS ACHIEVED WITH THE BACKFILL.
   ALL EXCAVATIONS SHALL BE PERFORMED IN A MANNER THAT SHALL BE KISURE PROPER DRAINAGE DURING THE COURSE OF WORK. FLOODED EXCAVATIONS SHALL BE EVENTLEED AND ALL MOCK SHALL BE REMOVED BEFORE SUFFICIENTLY SUPPORTED TO PREVENT COLLAPSE.
   AFTER EXCAVATION, EXPOSED SOLI SURFACES SHALL BE SUFFICIENTLY SUPPORTED TO PREVENT TO LAPSE.
   AFTER EXCAVATION, AND EXCAVATION METHOD BASED ON THE CONSTRUCTION AND EXCAVATION METHOD BASED ON THE RESPONSIBILITY OF THE CONTRACTOR TO ADOPT PROPER CONSTRUCTION AND EXCAVATION METHOD BASED ON THE SOLIC CONDITION FOUND ON SITE.
   ALL EXCAVATION, BACKFILL AND INSTALLATION SHALL BE INSPECTED BY A QUALIFIED GEOTECHNICAL PERSONNEL. TO CONFIRM THAT THE SOLIP PROPER TES ARE CONSISTENT WITH THE GEOTECHNICAL INVESTIGATION REPORT AND DESIGN PARAMETERS
   ALL BACKFILL SURROUNDING FOUNDATIONS SHALL BE NUMBER TO THE CONFORMS TO RECOMMENDED SPECIFICATIONS FOR GRANULAR MATERIALS IN THE GEOTECHNICAL PERSONNEL. TO CONSTRUCTION WORKS SHALL BE PROVIDED AFTER EXCAVATION AND SHALL BE COMPACTED TO 95% SPMDD WITH MAX LIFT OF 300mm.
   SAFETY MEASURES SHALL BE PROVIDED AFTER EXCAVATION ALL CONSTRUCTION WORKS SHALL BE PERFORMED IN ALCORDANCE WITH PROJECT SPECIFICATIONS AS LISTED ABOVE, ALL CONSTRUCTION WORKS SHALL BE PERFORMED IN ACCORDANCE WITH PROJECT SPECIFICATIONS AS LISTED AS FOULDWS WHEN THEY ARE APPLICABLE:
   A CAISSON DELLING B. FOUNDATION THEY ARE APPLICABLE:
   C. REINFORCED CONCRETE


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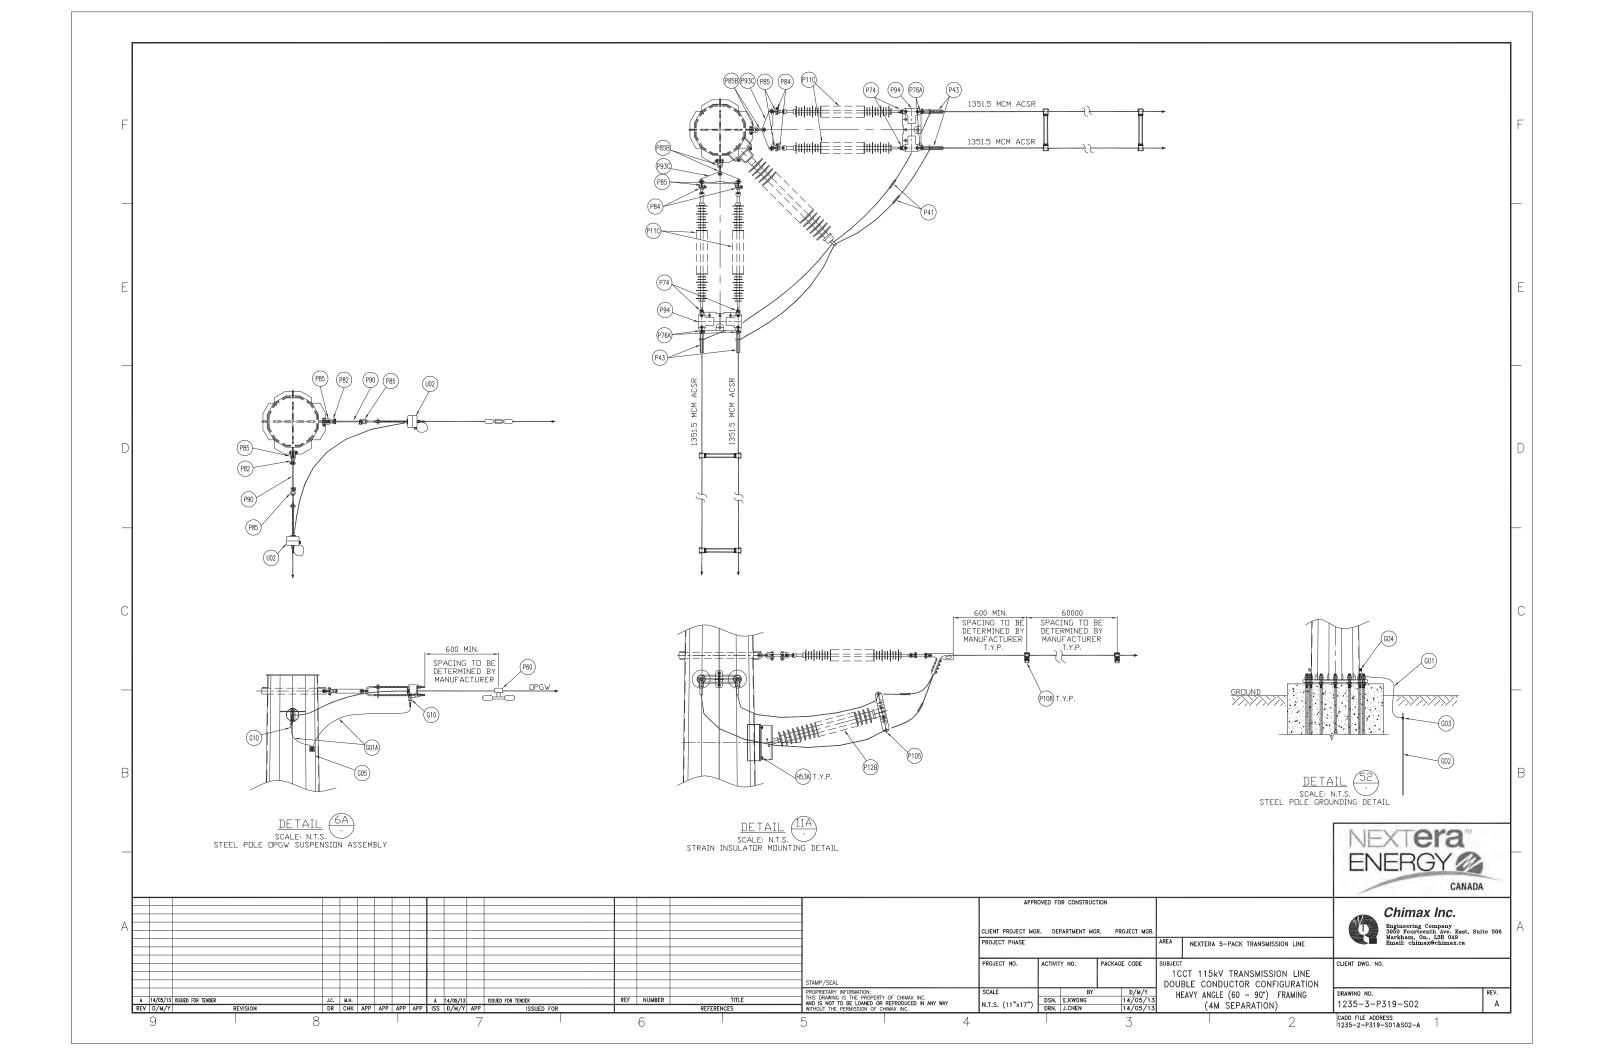





3     3     4     5     6     5     6     5       2     2     2     2     5     5     6     5       2     3     5     7     6     5       3     5     5     6     7     6     5       3     5     7     6     5     5       3     5     7     6     5       5     5     7     6     7     6     5       5     5     7     6     7     6     5       5     5     7     6     7     6     5       5     5     7     6     7     6     7     6       6     7     6     7     6     7     6     7       6     7     6     7     6     7     6     7       6     7     7     7     6     7     6     7     6     7       7     8     7     6     8     6     7     6     7     6       9     7     7     7     7     7     7     7     7     7     7     7     7     7     7     7     7 </th <th>1       1       1       1       1         2       8       9       10         2       8       9       10         2       8       9       10         2       8       9       10         2       8       9       10         1       15       BRANNO SHALL BE FRAD IN CONJUNCTION WITH THE FLAN AND PROFILE (DW047335-3-F012), ANCHOR BOLT DRAWIS, SHO STAKING INFORMATION, FOR STRUCTURE SHOW ON DECIME FOR THE FOUNDATION DESIGN ALL DIMENSIONS AS SHOWN ARE WITH ON MULTING UNDER UNDER GOUND WATHER LEAL IS DESIGNED FOR THE FOUNDATION DESIGN AND ASSIMPTIONS ACE ADOPTION FOR THE FOUNDATION DESIGN AND ASSIMPTION WITH FILTER LED WITH FILTEN INDER UNDER UNDER FOR STRUCTURE B-NORT TO EMODE FRANCE PENETRATION INDEX 'N' = 8 ( FOR STRUCTURE B-NORT TO EMODE GRADE, AVERAGE FENETRATION INDEX 'N' = 10 ( FOR STRUCTURE B-NORT TO EMODE AND CONSTRUCTION SHALL BE IN ACC PENNESS OFTENDARIA DESIGNE STRUCTURE NUD CONSTRUCTION SHALL BE IN ACC WITH CSA STANDARD CAN Z-AZ3 SERIES.         2       FOR THE CAS STANDARD CONCETE SHALL BE AS FOLLOWS: MULTING STRUCTURE B-NORT TO EMODIATION DESIGN. TYPE OF UNDEXAL PORTANO CONCETE CORE TO CAR AT 20 DEDEE FLACING STRUCTURE STRUCTURE MULTING CONCETE CORE TO CAR AT 20 DEDEDENT OF CONCETENCIN NUM CONCETE CORE TO CAS AND TWO AT 28 DAYS ARE SECTION AND CONCETENT TYPE OF UNDEXAL PERTONICAL DE EMONY ALL BE IN ACC WITH CSA STANDARD CONCETENT TYPE OF UNDEXAL PORTANO CEMENT 10 DESCRUCTURE STRUCTURE STRUCTURE MULTING CONTROL TO CAR AT 20 DEVERTION ON THE CONCEST TO TAKE AND TWO AT 28 DAYS ARE UNDEXALTORY AND CONCETE CONTACT TO A CONSTRUCTION OF THE STOCETER CORE AND TWO AT 28 DAYS 35 FOLLOWS: SECOFICATION AND CONCETE CONT</th> <th></th>	1       1       1       1       1         2       8       9       10         2       8       9       10         2       8       9       10         2       8       9       10         2       8       9       10         1       15       BRANNO SHALL BE FRAD IN CONJUNCTION WITH THE FLAN AND PROFILE (DW047335-3-F012), ANCHOR BOLT DRAWIS, SHO STAKING INFORMATION, FOR STRUCTURE SHOW ON DECIME FOR THE FOUNDATION DESIGN ALL DIMENSIONS AS SHOWN ARE WITH ON MULTING UNDER UNDER GOUND WATHER LEAL IS DESIGNED FOR THE FOUNDATION DESIGN AND ASSIMPTIONS ACE ADOPTION FOR THE FOUNDATION DESIGN AND ASSIMPTION WITH FILTER LED WITH FILTEN INDER UNDER UNDER FOR STRUCTURE B-NORT TO EMODE FRANCE PENETRATION INDEX 'N' = 8 ( FOR STRUCTURE B-NORT TO EMODE GRADE, AVERAGE FENETRATION INDEX 'N' = 10 ( FOR STRUCTURE B-NORT TO EMODE AND CONSTRUCTION SHALL BE IN ACC PENNESS OFTENDARIA DESIGNE STRUCTURE NUD CONSTRUCTION SHALL BE IN ACC WITH CSA STANDARD CAN Z-AZ3 SERIES.         2       FOR THE CAS STANDARD CONCETE SHALL BE AS FOLLOWS: MULTING STRUCTURE B-NORT TO EMODIATION DESIGN. TYPE OF UNDEXAL PORTANO CONCETE CORE TO CAR AT 20 DEDEE FLACING STRUCTURE STRUCTURE MULTING CONCETE CORE TO CAR AT 20 DEDEDENT OF CONCETENCIN NUM CONCETE CORE TO CAS AND TWO AT 28 DAYS ARE SECTION AND CONCETENT TYPE OF UNDEXAL PERTONICAL DE EMONY ALL BE IN ACC WITH CSA STANDARD CONCETENT TYPE OF UNDEXAL PORTANO CEMENT 10 DESCRUCTURE STRUCTURE STRUCTURE MULTING CONTROL TO CAR AT 20 DEVERTION ON THE CONCEST TO TAKE AND TWO AT 28 DAYS ARE UNDEXALTORY AND CONCETE CONTACT TO A CONSTRUCTION OF THE STOCETER CORE AND TWO AT 28 DAYS 35 FOLLOWS: SECOFICATION AND CONCETE CONT	
12200 [40'-1/2"]	AND ALL MUCK SHALL BE REMOVED BEFORE PROCEEDING WITH WORK, ALL EX ANTER EXCAVATION, EXPOSED SOIL SURFACES SHALL BE PROTECTED PRIOR TO CONSTRUCTION AND EXCAVATION METHOD BASED ON THE CONTRACTOR TO ADD PRIOR TO THE PLACEMENT OF CONCRETE, BOTTOM OF THE CONTRACTOR SHALL BE PROPER TO THE PLACEMENT OF CONCRETE, BOTTOM OF FOUNDATIONS SHALL BE STOUALIFED GEOTECHNICAL PERSONNEL TO CONFIRM THAT THE SOIL PROPE CONSISTENT WITH THE GEOTECHNICAL INVESTIGATION REPORT AND DESIGN PA BEFORE PLACING CONCRETE, CONTRACTOR SHALL VERIFY ANCHOR BOLTS AND PROPER WIBRATION METHODS SHALL BE USED DURING CONCRETING. CONCRETE SHALL BE ADEQUATELY CURED BY ADDITIONAL MOISTURE AND/OR MATER REFLAINING MATERIAL AFTER POURING. ALL EXPOSED CONCRETE EDGES SHALL HAVE A 25mm CHAMFER ALL EXPOSED CONCRETE EDGES SHALL HAVE A 25mm CHAMFER ALL BACKFILL UNDER FOUNDATIONS SHALL BE WELL GRADD PIT RUN CONFORMS TO RECOMPACTED FOOTIONS SHALL BE MELL GRADD WITH MAX ATERIAL AND SHALL BE COMPACTED TO 305% SMDD WITH MAX LIFT OF 200 SAFETY MEASURES SHALL BE PROVIDED AFTER EXCAVATION TO ENSURE WORK SAFETY.	
NOTES 7)	NOT FOR CONSTRUCTION DESIGN IN PROGRESS	
Image: Stamp sector       Image: Stamp sector         Image: Stamp sector       Image: Stamp sector <td>APPROVED FOR CONSTRUCTION       APPROVED FOR CONSTRUCTION       Chimax Inc.         CLIENT PROJECT MGR.       DEPARTMENT MGR.       PROJECT MGR.       P</td> <td><math>\triangleright</math></td>	APPROVED FOR CONSTRUCTION       APPROVED FOR CONSTRUCTION       Chimax Inc.         CLIENT PROJECT MGR.       DEPARTMENT MGR.       PROJECT MGR.       P	$\triangleright$

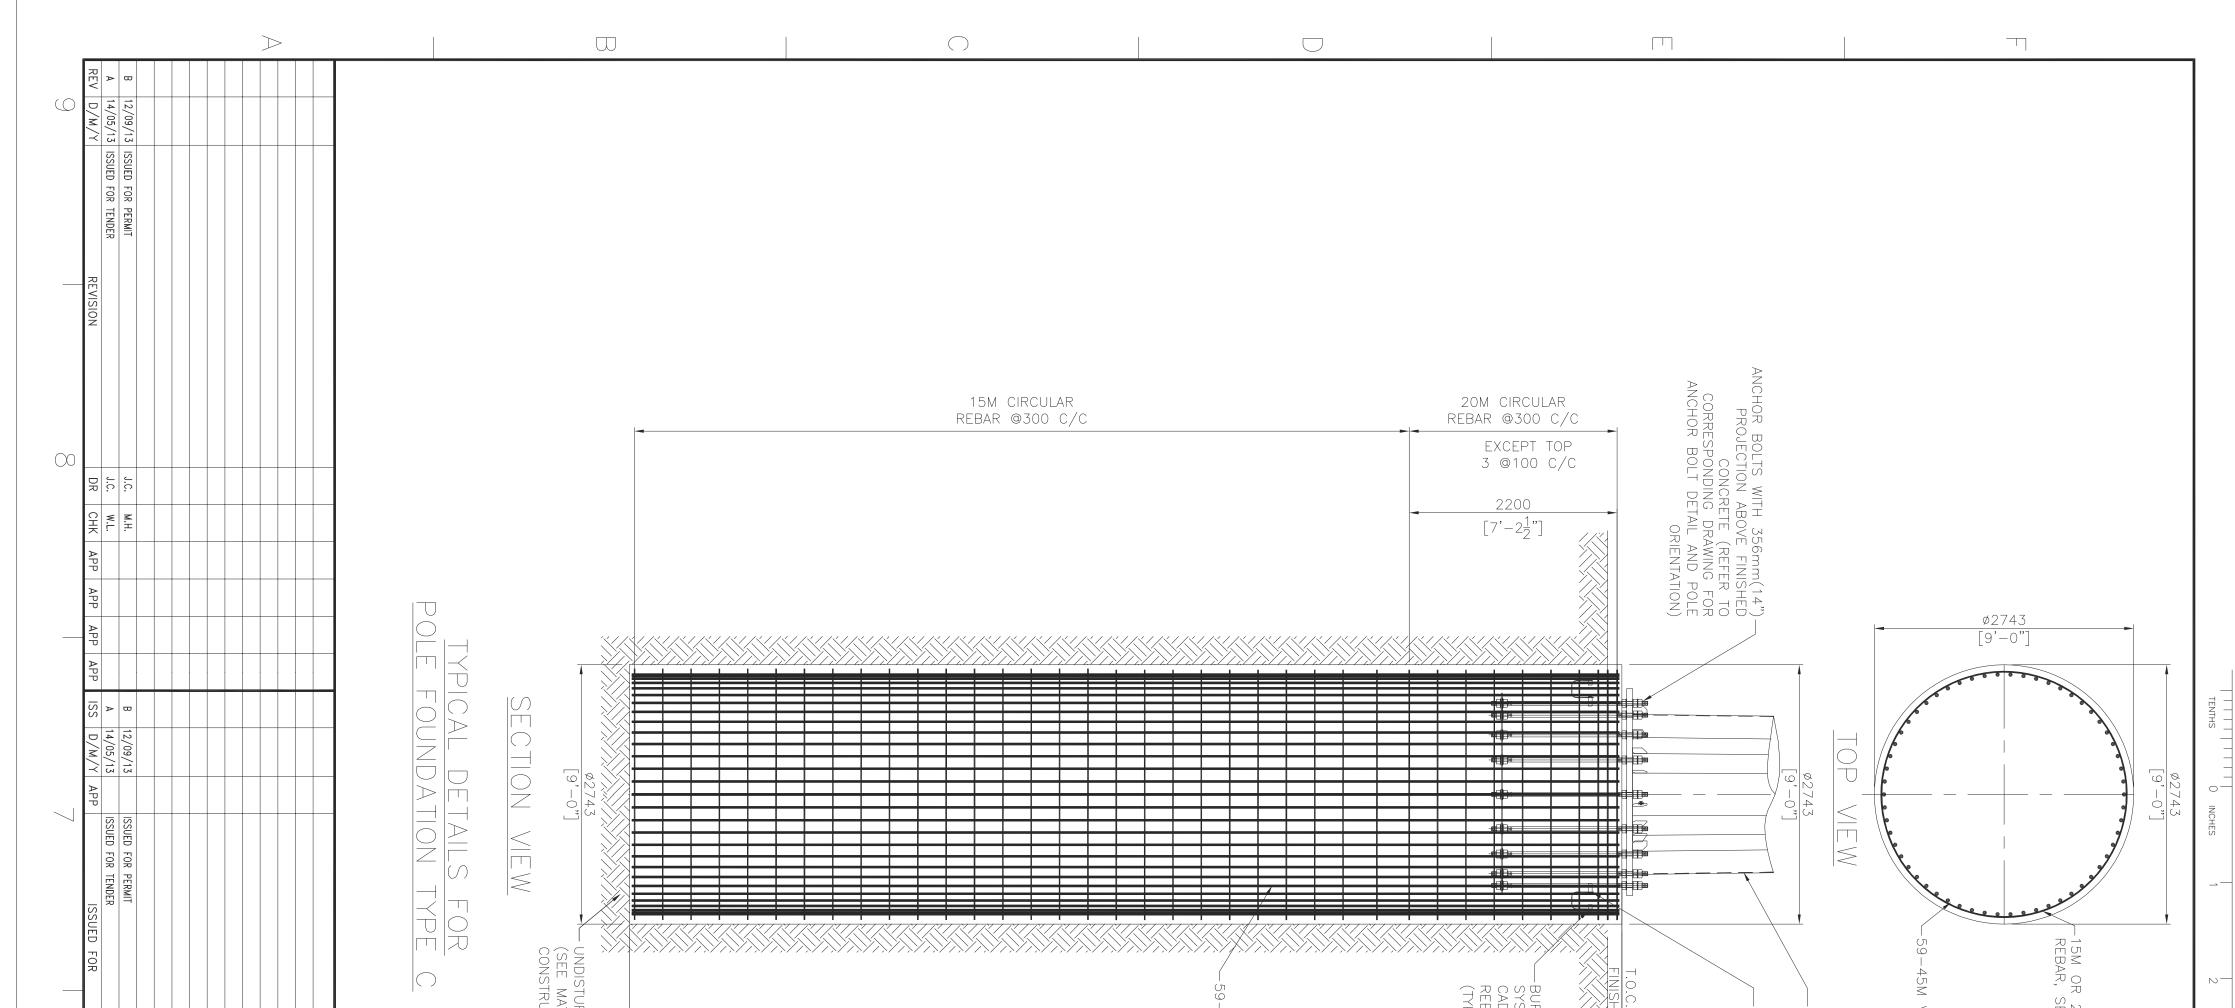



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DESCRIPTION	MANUFACTURER/NO	REMARKS	
DLE LENGTH & CLASS, SEE	OR EQUIVALENT		
ING TABLE) N LINE SUSPENSION INSULATOR (SML	NGK-LOCKE		
BALL ENDS)	PART #301-SC390-SJ		F
SION LINE POST INSULATOR (DROP E)	NGK-LOCKE PART #L4-SN321-18		ľ
E FOR AL. CONDUCTOR 1351.5MCM	HUBBELL A151561		1
N CLAMP FOR AL CONDUCTOR	HUBBELL SD155N		
PER) (UTS 35,000LBS)		STROUDDIDGE	
FOR 48 FIBERS OPGW (REF: R2)		STOCKBRIDGE TYPE OR SPIRAL	
INECTOR (30,000LBS UTS)	HUBBELL SC301	TYPE (T.B.A.)	
TOR (UTS 30,000LBS)	HUBBELL CE054125		
0 DEG. CONNECTOR (UTS 30,000LBS)	HUBBELL YCC3090		
INECTOR (UTS 30,000LBS) TS 40,000LBS)	HUBBELL YBC30 HUBBELL AS35BNK		
TS 60,000LBS>	HUBBELL AS50WBNK		
2" LENGTH, UTS 30,000LBS)	HUBBELL ES30781912		Ε
ATE (UTS 60,000LBS) ATE (UTS 30,000LBS)	HUBBELL YPD60183771 HUBBELL YPR30187221		
AL. CONDUCTOR 1351.5MCM ACSR	HUBBELL 2717243001		
TION DAMPER FOR TWO AL.	PFISTERER		
M ACSR (DIPPER) (18" SPACING)	182 952-195		
325 BOLT + 2×FLAT WASHER + NUT			
STR. Cu.)			
STR. Cu.) ID ROD, 3/4″ DIA. 10′ LENGTH		T.B.A.	
FOR 3/4" DIA. TO 2/0 STR. Cu.	HUBBELL C2030345	L'B'H'	
UND CLAMP FOR #4 SOL TO 4/0	HUBBELL GC141AG2		1
JUND CLAMP FOR #2 7STR. Cu. & #2	HUBBELL GC143G1		
N TERMINAL FOR #2 7STR, Cu, (C/W	HUBBELL BCL018B		D
2 48 FIBERS DPGW (REF: R2), C/W HARDWARE FOR TERMINAL	PLP 2801309		
5,000LBS)			
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T 115kV TRANSMISSION LINE	Chimax Engineering Cor 3950 Fourteent Markham, On. Email: chimaxe	Inc. npany Ave. East, Suite 506 Sign 0.9 chimax.ca	A
LE CONDUCTOR CONFIGURATION	RAWING NO.	REV.	
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2 <sup>c</sup>	ADD FILE ADDRESS 235-2-P319-S01&S02-A	1	

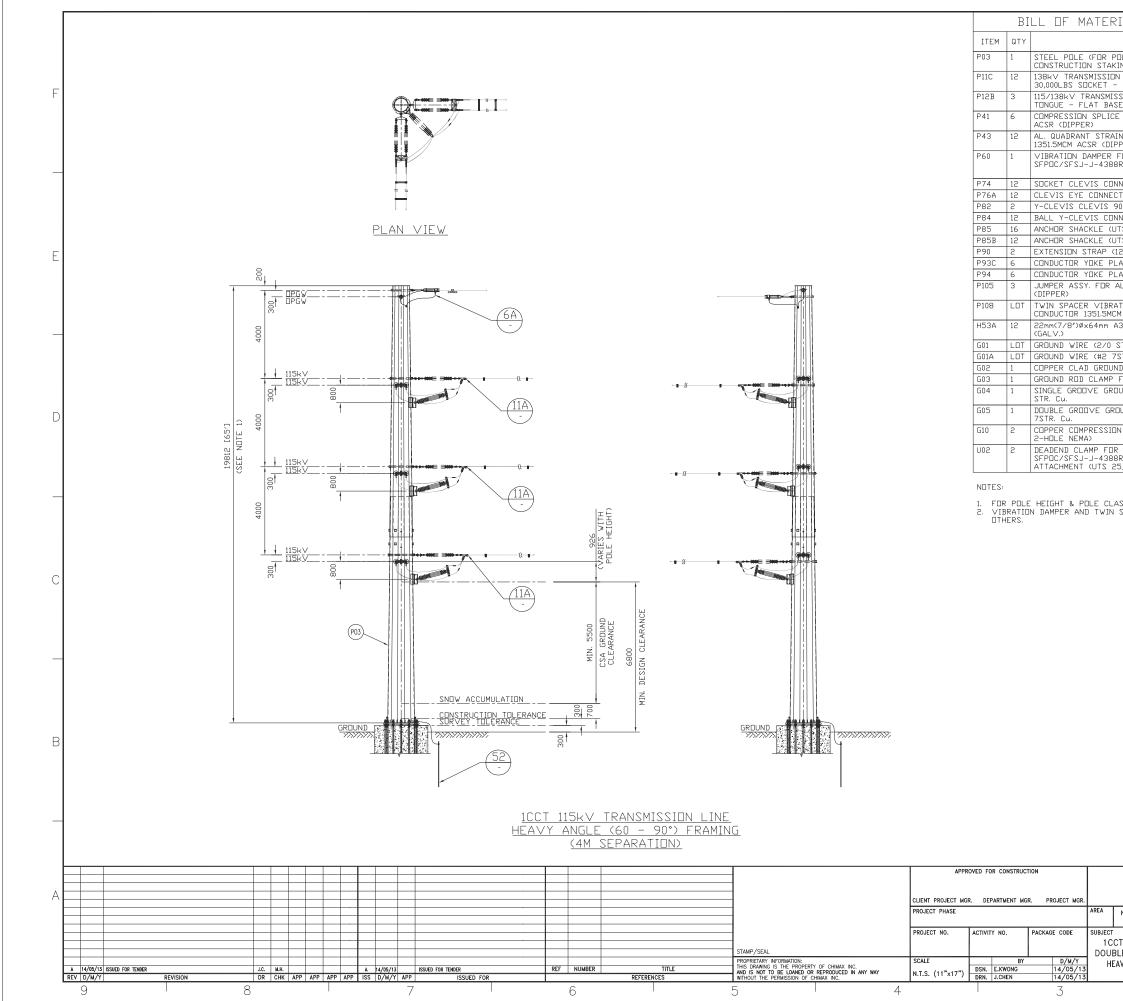

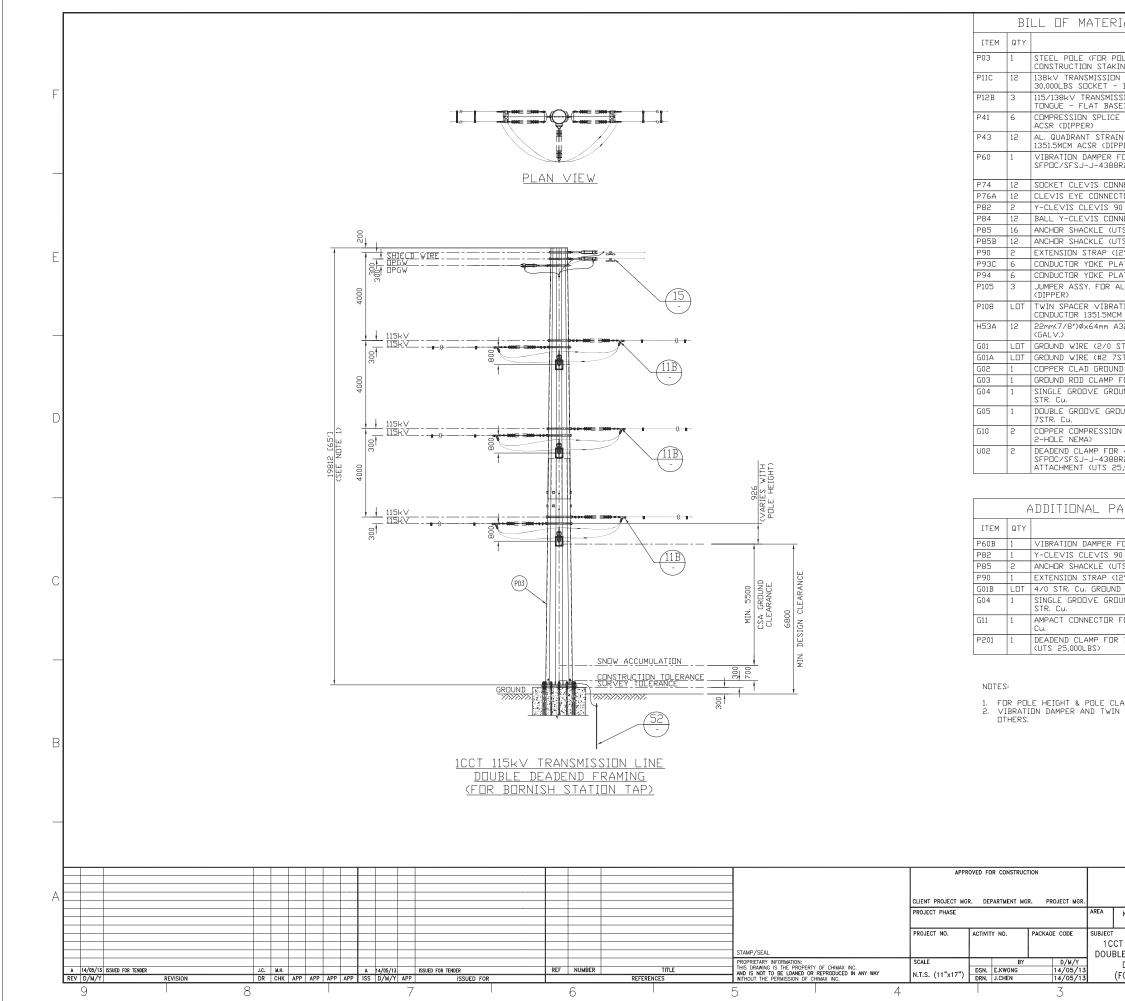



IAL (QUANTITIES SHOW		1BLY>
DESCRIPTION	MANUFACTURER/NO OR EQUIVALENT	REMARKS
DLE LENGTH & CLASS, SEE ING TABLE)		
N LINE SUSPENSION INSULATOR (SML • BALL ENDS)	NGK-LOCKE PART #301-SC390-SJ	
SION LINE POST INSULATOR (DROP	NGK-LOCKE	
E) E FOR AL. CONDUCTOR 1351.5MCM	PART #L4-SN321-18 HUBBELL A151561	
IN CLAMP FOR AL CONDUCTOR PPER) (UTS 35,000LBS)	HUBBELL SD155N	
FOR 48 FIBERS OPGW (REF: 3R2)		STOCKBRIDGE TYPE OR SPIRAL
		TYPE (T.B.A.)
INECTOR (30,000LBS UTS)	HUBBELL SC301 HUBBELL CE054125	
0 DEG. CONNECTOR (UTS 30,000LBS)	HUBBELL YCC3090	
INECTOR (UTS 30,000LBS) TS 40,000LBS)	HUBBELL YBC30 HUBBELL AS35BNK	
TS 60,000LBS>	HUBBELL AS50WBNK	
2" LENGTH, UTS 30,000LBS)	HUBBELL ES30781912	
ATE (UTS 60,000LBS) ATE (UTS 30,000LBS)	HUBBELL YPD60183771 HUBBELL YPR30187221	
AL. CONDUCTOR 1351.5MCM ACSR	HUBBELL 2717243001	
TION DAMPER FOR TWO AL.	PFISTERER	
M ACSR (DIPPER) (18" SPACING) 325 BOLT + 2×FLAT WASHER + NUT	182 952-195	
STR. Cu.) STR. Cu.)		
ID ROD, 3/4" DIA. 10' LENGTH	<u> </u>	T.B.A.
FOR 3/4″ DIA. TO 2/0 STR. Cu. IUND CLAMP FOR #4 SOL TO 4/0	HUBBELL C2030345 HUBBELL GC141AG2	
JUND CLAMP FOR #2 7STR. Cu. & #2	HUBBELL GC143G1	
N TERMINAL FOR #2 7STR. Cu. (C/W	HUBBELL BCL018B	
2 48 FIBERS DPGW (REF: BR2), C/W HARDWARE FDR TERMINAL	PLP 2801309	
5,000LBS)		
ARTS FOR SHIELD WIRE	- TAP TH STAT	
	MANUFACTURER/NO	1
	OR EQUIVALENT	REMARKS
FOR 7#5 ALUMOWELD SHIELD WIRE	HUBBELL 607051011 HUBBELL YCC3090	
U DEG. CUNNECTUR (UTS 30,000LBS)		
	HUBBELL AS35BNK	
TS 40,000LBS) 2" LENGTH, UTS 30,000LBS)		
TS 40,000LBS) 2" LENGTH, UTS 30,000LBS) D WIRE	HUBBELL AS35BNK	
TS 40,000LBS) 2" LENGTH, UTS 30,000LBS) D WIRE UND CLAMP FOR #4 SOL TO 4/0	HUBBELL AS35BNK HUBBELL ES30781912	
TS 40,000LBS) 2" LENGTH, UTS 30,000LBS) D WIRE UND CLAMP FOR #4 SOL TO 4/0 FOR 7#5 ALUMOVELD TO 4/0 STR.	HUBBELL AS35BNK HUBBELL ES30781912 HUBBELL GC141AG2 AMP 600466	
TS 40,000LBS) 2" LENGTH, UTS 30,000LBS) D WIRE UND CLAMP FOR #4 SOL TO 4/0 FOR 7#5 ALUMOWELD TO 4/0 STR.	HUBBELL AS35BNK HUBBELL ES30781912 HUBBELL GC141AG2	
TS 40,000LBS) 2" LENGTH, UTS 30,000LBS) D WIRE JUND CLAMP FOR #4 SOL TO 4/0 FOR 7#5 ALUMOWELD TO 4/0 STR. 2" 7#5 ALUMOWELD SHIELD WIRE ASS, SEE CONSTRUCTION STAKING T	HUBBELL AS35BNK HUBBELL ES30781912 HUBBELL GC141AG2 AMP 600466 PLP VG-18-3000 ABLE.	
AD DEG. CUNNECTOR (UTS 30,000LBS) TS 40,000LBS) 12" LENGTH, UTS 30,000LBS) D WIRE JUND CLAMP FOR #4 SOL TO 4/0 FOR 7#5 ALUMOWELD TO 4/0 STR. R 7#5 ALUMOWELD SHIELD WIRE ASS, SEE CONSTRUCTION STAKING T. N SAPACER DAMPER TO BE ADVISED	HUBBELL AS35BNK HUBBELL ES30781912 HUBBELL GC141AG2 AMP 600466 PLP VG-18-3000 ABLE. BY	
TS 40,000LBS) 12" LENGTH, UTS 30,000LBS) D WIRE JUND CLAMP FOR #4 SOL TO 4/0 FOR 7#5 ALUMOWELD TO 4/0 STR. 2 7#5 ALUMOWELD SHIELD WIRE _ASS, SEE CONSTRUCTION STAKING T	HUBBELL AS35BNK HUBBELL ES30781912 HUBBELL GC141AG2 AMP 600466 PLP VG-18-3000 ABLE. BY	
TS 40,000LBS) 12" LENGTH, UTS 30,000LBS) D WIRE JUND CLAMP FOR #4 SOL TO 4/0 FOR 7#5 ALUMOWELD TO 4/0 STR. 2 7#5 ALUMOWELD SHIELD WIRE LASS, SEE CONSTRUCTION STAKING T. N SAPACER DAMPER TO BE ADVISED N SAPACER DAMPER TO BE ADVISED	HUBBELL AS35BNK HUBBELL ES30781912 HUBBELL GC141AG2 AMP 600466 PLP VG-18-3000 ABLE. BY	Inc.
TS 40,000LBS) L2" LENGTH, UTS 30,000LBS) D WIRE JUND CLAMP FOR #4 SOL TO 4/0 FOR 7#5 ALUMOWELD TO 4/0 STR. ? 7#5 ALUMOWELD SHIELD WIRE ASS, SEE CONSTRUCTION STAKING T. SAPACER DAMPER TO BE ADVISED NEXTERA 5-PACK TRANSMISSION LINE CT 115kV TRANSMISSION LINE	HUBBELL AS35BNK HUBBELL ES30781912 HUBBELL GC141AG2 AMP 600466 PLP VG-18-3000 ABLE. BY	Inc.
TS 40,000LBS) 12" LENGTH, UTS 30,000LBS) D WIRE JUND CLAMP FOR #4 SOL TO 4/0 FOR 7#5 ALUMOWELD TO 4/0 STR. 2 7#5 ALUMOWELD SHIELD WIRE ASS, SEE CONSTRUCTION STAKING T. N SAPACER DAMPER TO BE ADVISED N SAPACER DAMPER TO BE ADVISED NEXTERA 5-PACK TRANSMISSION LINE E CONDUCTOR CONFIGURATION DOUBLE DEADEND FRAMING	HUBBELL AS35BNK HUBBELL ES30781912 HUBBELL GC141AG2 AMP 600466 PLP VG-18-3000 ABLE. BY	Inc.

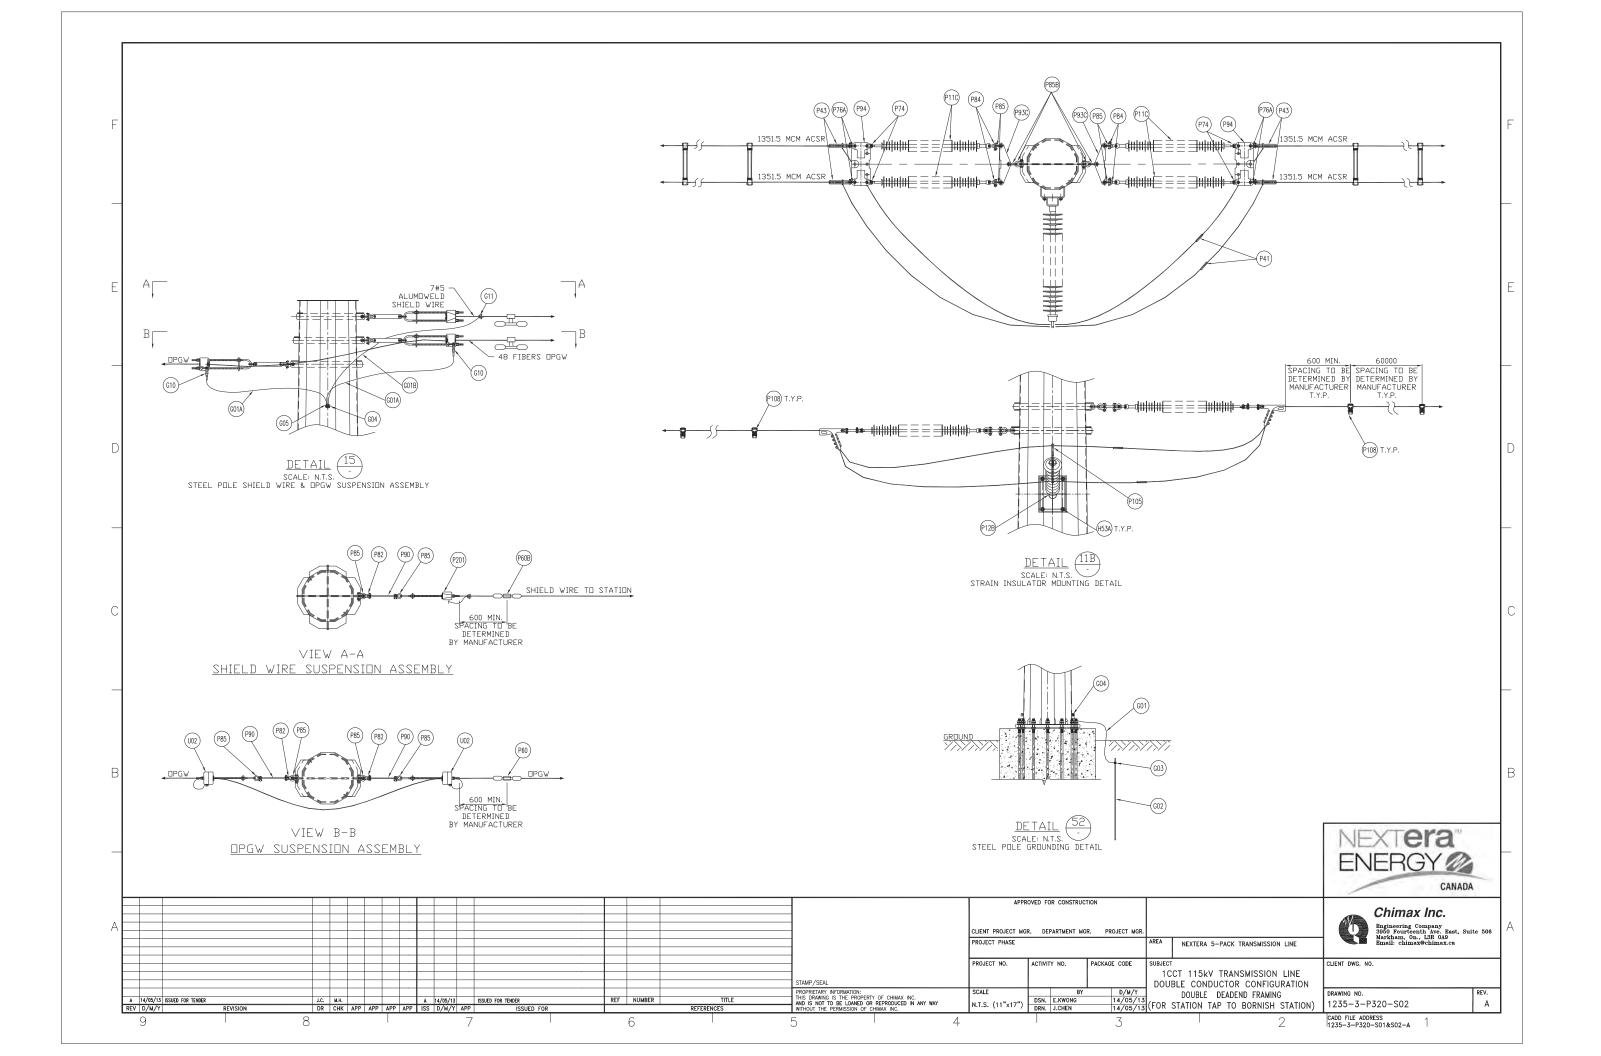

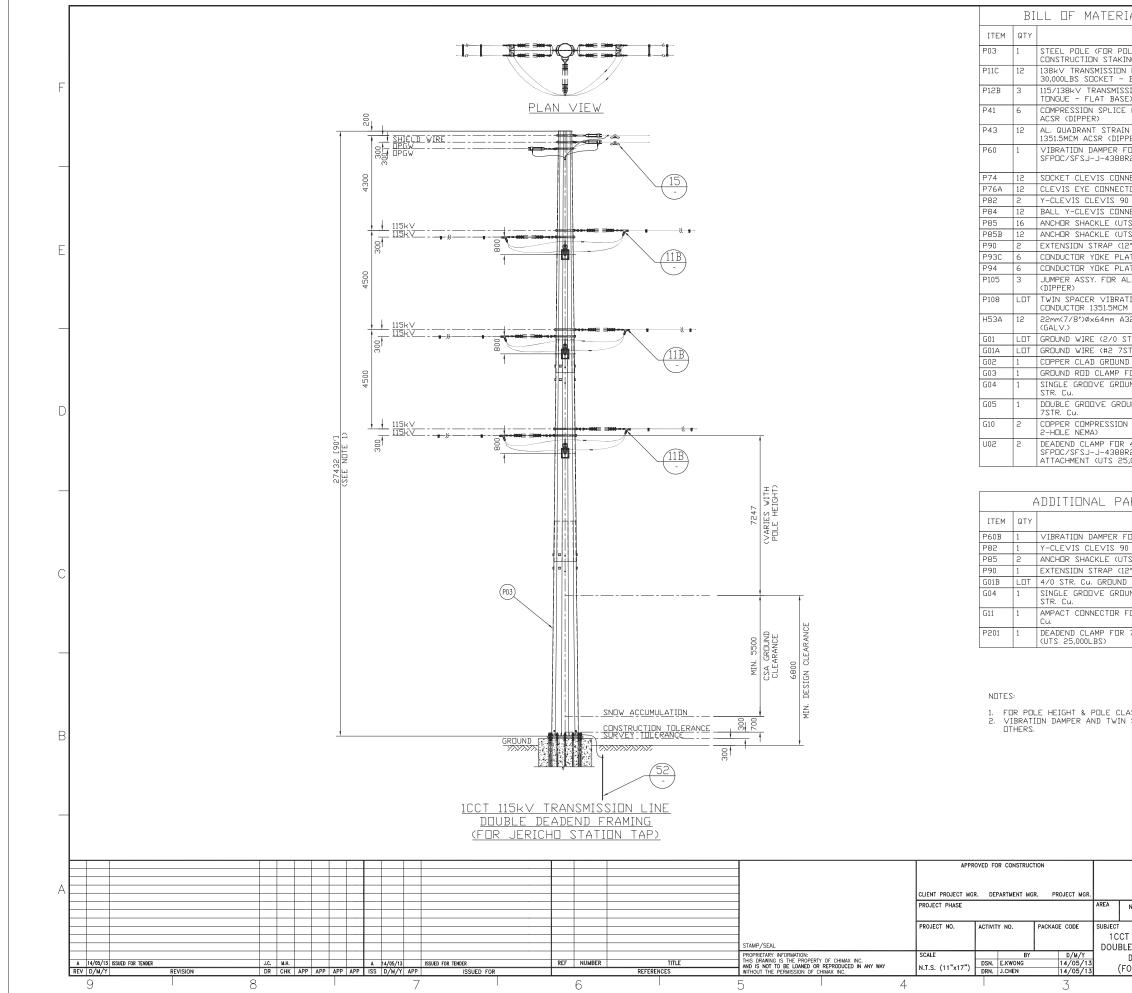



IAL (QUANTITIES SHOW		
INC (QUANTITIES SHUW		IBLY)
DESCRIPTION	MANUFACTURER/NO OR EQUIVALENT	REMARKS
JLE LENGTH & CLASS, SEE ING TABLE>		
LINE SUSPENSION INSULATOR (SML BALL ENDS)	NGK-LOCKE PART #301-SC390-SJ	
SION LINE POST INSULATOR (DROP	NGK-LOCKE	
E) FOR AL. CONDUCTOR 1351.5MCM	PART #L4-SN321-18 HUBBELL A151561	
N CLAMP FOR AL CONDUCTOR PER) (UTS 35,000LBS)	HUBBELL SD155N	
FDR 48 FIBERS DPGW (REF: R2)		STOCKBRIDGE TYPE OR SPIRAL
		TYPE (T.B.A.)
NECTOR (30,000LBS UTS) TOR (UTS 30,000LBS)	HUBBELL SC301 HUBBELL CE054125	
0 DEG. CONNECTOR (UTS 30,000LBS)	HUBBELL YCC3090	
NECTER (UTS 30,000LBS) S 40,000LBS)	HUBBELL YBC30 HUBBELL AS35BNK	
S 60,000LBS)	HUBBELL ASSOBNK	
2″ LENGTH, UTS 30,000LBS>	HUBBELL ES30781912	
ATE (UTS 60,000LBS) ATE (UTS 30,000LBS)	HUBBELL YPD60183771 HUBBELL YPR30187221	
L. CONDUCTOR 1351.5MCM ACSR	HUBBELL 2717243001	
TION DAMPER FOR TWO AL.	PFISTERER	
4 ACSR (DIPPER) (18" SPACING)	182 952-195	
325 BOLT + 2×FLAT WASHER + NUT		
STR. Cu.)		
STR. Cu.) D ROD, 3/4″ DIA. 10′ LENGTH		T.B.A.
FOR 3/4" DIA. TO 2/0 STR. Cu.	HUBBELL C2030345	יחישיי
UND CLAMP FOR #4 SOL TO 4/0	HUBBELL GC141AG2	
UND CLAMP FOR #2 7STR. Cu. & #2	HUBBELL GC143G1	
N TERMINAL FOR #2 7STR. Cu. (C/W	HUBBELL BCL018B	
48 FIBERS DPGW (REF: R2), C/W HARDWARE FOR TERMINAL	PLP 2801309	
5,000LBS)		
ARTS FOR SHIELD WIRE	TAP TO STAT	IDN
	MANUFACTURER/NO	REMARKS
	OR EQUIVALENT	REMARKS
O DEG. CONNECTOR (UTS 30,000LBS)	HUBBELL 607051011 HUBBELL YCC3090	
TS 40,000LBS)	HUBBELL AS35BNK	
2" LENGTH, UTS 30,000LBS)	HUBBELL ES30781912	
UND CLAMP FOR #4 SOL TO 4/0	HUBBELL GC141AG2	
FOR 7#5 ALUMOWELD TO 4/0 STR.	AMP 600466	
FOR 7#5 ALUMOWELD TO 4/0 STR.	PLP VG-18-3000	
FOR 7#5 ALUMOWELD TO 4/0 STR. 7#5 ALUMOWELD SHIELD WIRE	PLP VG-18-3000	ra
FOR 7#5 ALUMOWELD TO 4/0 STR. 2 7#5 ALUMOWELD SHIELD WIRE ASS, SEE CONSTRUCTION STAKING TA N SAPACER DAMPER TO BE ADVISED TO NEXTERA 5-PACK TRANSMISSION LINE	PLP VG-18-3000	CANADA CANADA CANADA
FOR 7#5 ALUMOWELD TO 4/0 STR. 7#5 ALUMOWELD SHIELD WIRE ASS, SEE CONSTRUCTION STAKING TA I SAPACER DAMPER TO BE ADVISED 1 NEXTERA 5-PACK TRANSMISSION LINE T 115kV TRANSMISSION LINE	PLP VG-18-3000 ABLE. BY NEXTERIOR ENERG ENERG Sof Point Cent Markham, On., Engli chimax	Inc.
FOR 7#5 ALUMOWELD TO 4/0 STR. 7#5 ALUMOWELD SHIELD WIRE ASS, SEE CONSTRUCTION STAKING TA SAPACER DAMPER TO BE ADVISED TO NEXTERA 5-PACK TRANSMISSION LINE TE 115kV TRANSMISSION LINE LE CONDUCTOR CONFIGURATION	PLP VG-18-3000 ABLE. BY NEXTERIOR ENERG ENERG Sof Point Cent Markham, On., Engli chimax	Inc.

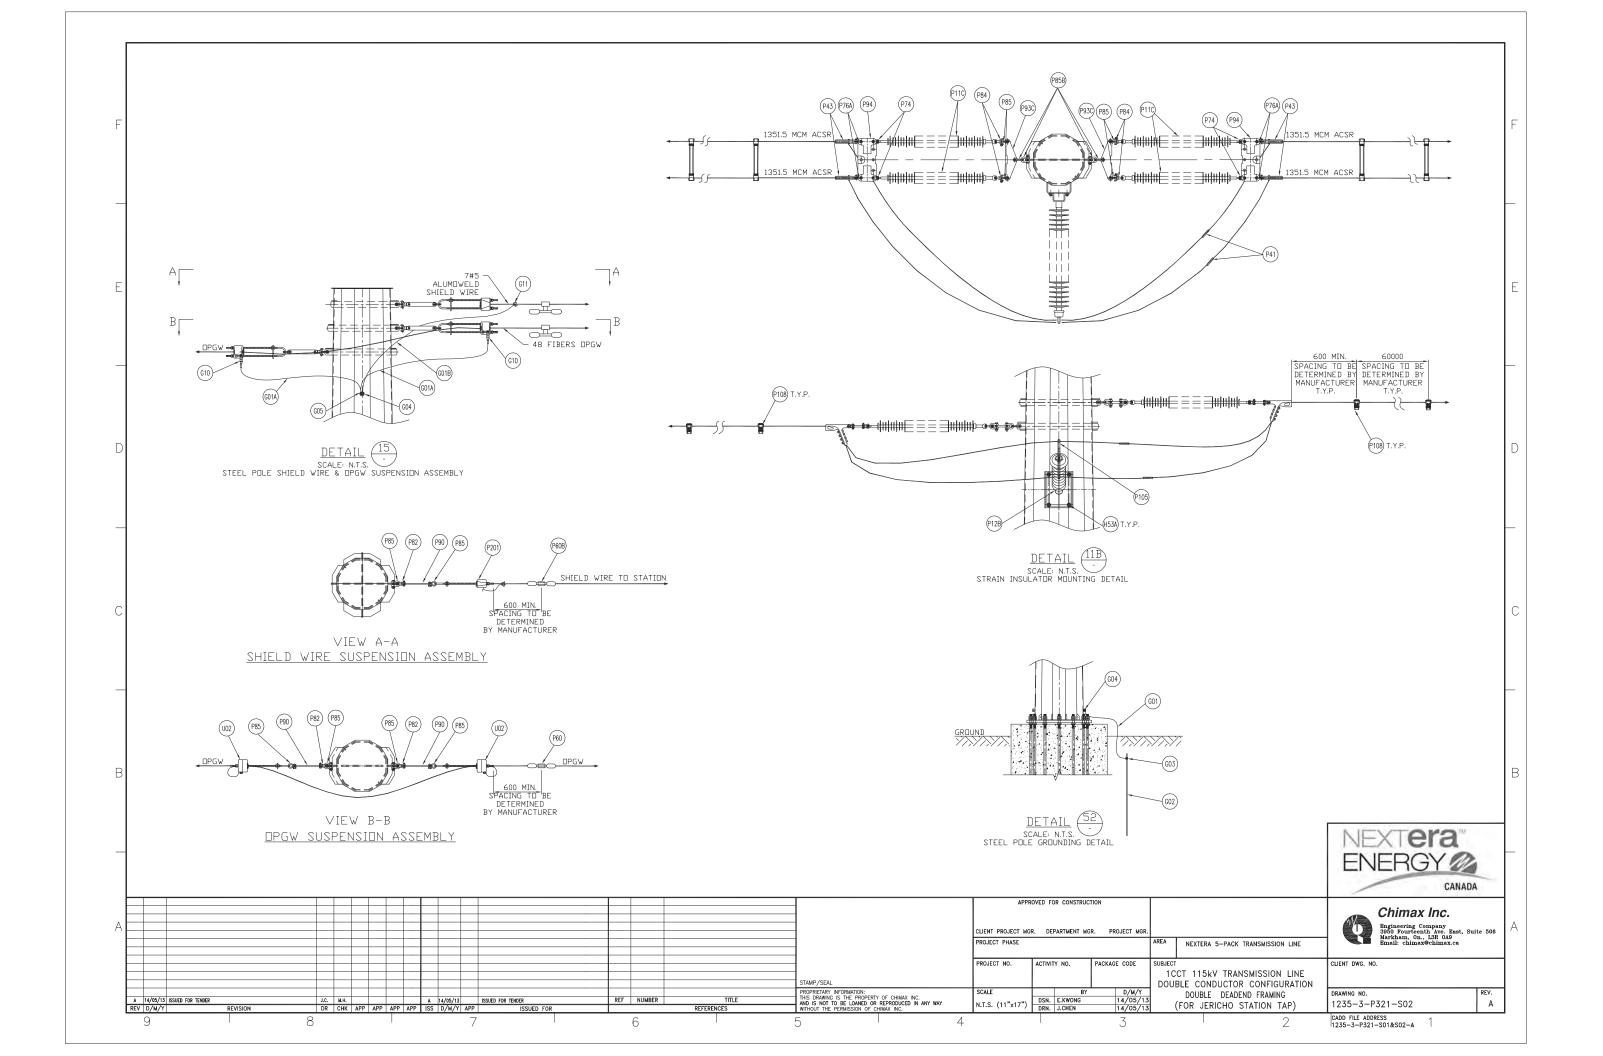

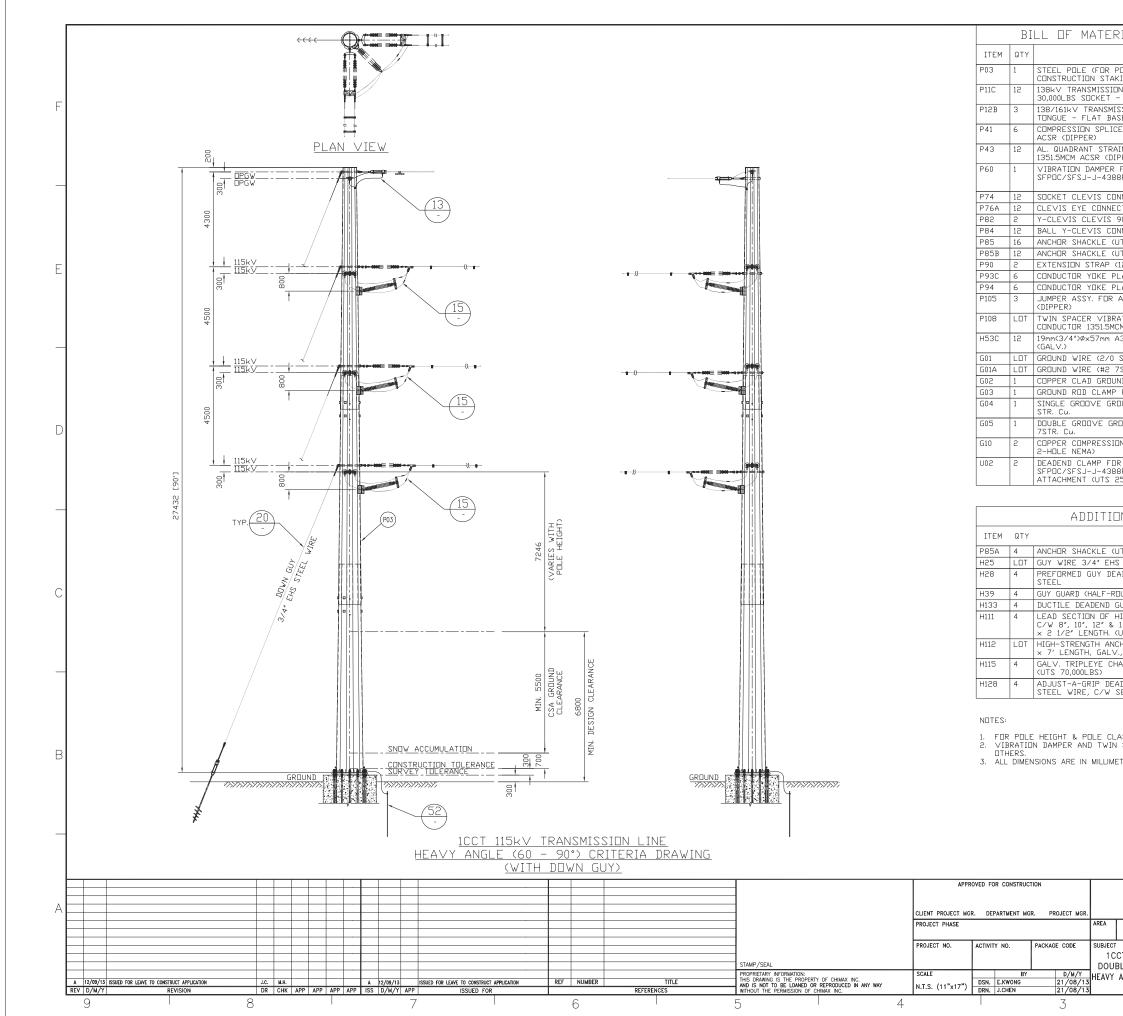



IAL (QUANTITIES SHOWN	V FOR 1 ASSEM	1BLY)
DESCRIPTION	MANUFACTURER/NO	REMARKS
DLE LENGTH & CLASS, SEE	OR EQUIVALENT	
ING TABLE) N LINE SUSPENSION INSULATOR (SML	NGK-LOCKE	
BALL ENDS)	PART #301-SC390-SJ	
SION LINE POST INSULATOR (DROP SE)	NGK-LOCKE PART #L2-SN371-18	
E FOR AL, CONDUCTOR 1351.5MCM	HUBBELL A151561	
N CLAMP FOR AL CONDUCTOR PPER) (UTS 35,000LBS)	HUBBELL SD155N	
FOR 48 FIBERS OPGW (REF:		STOCKBRIDGE
3R2)		TYPE OR SPIRAL TYPE (T.B.A.)
NECTOR (30,000LBS UTS)	HUBBELL SC301	
TER (UTS 30,000LBS) 0 DEG. CENNECTER (UTS 30,000LBS)	HUBBELL CE054125 HUBBELL YCC3090	
NECTOR (UTS 30,000LBS)	HUBBELL YBC30	
TS 40,000LBS>	HUBBELL AS35BNK	
TS 60,000LBS) 2″ LENGTH, UTS 30,000LBS)	HUBBELL AS50WBNK HUBBELL ES30781912	
ATE (UTS 60,000LBS)	HUBBELL YPD60183771	
ATE (UTS 30,000LBS)	HUBBELL YPR30187221	
AL CONDUCTOR 1351.5MCM ACSR	HUBBELL 2717243001	
TION DAMPER FOR TWO AL. M ACSR (DIPPER) (18″ SPACING)	PFISTERER 182 952-195	
325 BOLT + 2×FLAT WASHER + NUT		
STR. Cu.)		
STR. Cu.)		
D RDD, 3/4" DIA. 10' LENGTH		T.B.A.
FOR 3/4" DIA. TO 2/0 STR. Cu. UND CLAMP FOR #4 SOL TO 4/0	HUBBELL C2030345 HUBBELL GC141AG2	
JUND CLAMP FOR #2 7STR. Cu. & #2	HUBBELL GC143G1 HUBBELL BCL018B	
: 48 FIBERS DPGW (REF: R2), C/W HARDWARE FOR TERMINAL 5,000LBS)	PLP 2801309	
NAL PARTS FOR SINGLE		
DESCRIPTION	MANUFACTURER/NO OR EQUIVALENT	
CZELODO,000LBS)	HUBBELL AS50BNK	
GALVANIZED STEEL DEND FOR 3/4" EHS GALVANIZED	PLP BG-2112	
UND MARKER 2" DIA. × 8' LENGTH) UY THIMBLE CLEVIS (UTS 60,000LBS)	HUBBELL 96PBG-2Y HUBBELL DDT12	AS REQ'D
IGH-STRENGTH SS ANCHORS (GALV.),	HUBBELL T1100521	
L4″ DIA. HELIX AND 1 1/2″ DIA. ROD JTS 70,000LBS)		
HOR ROD EXTENSION, 1 1/2″ DIA. ROD , (UTS 70,000LBS)	HUBBELL C1100389	AS REQ'D
AIN SHACKLE, FOR 1 1/2″ DIA. ROD	HUBBELL C1100574	
DEND GRIPS FOR 3/4" EHS GALV.	HUBBELL 34GA18S	
ERVING SLEEVE (UTS 58,000LBS)	NUDDELE UTUMIOS	
NS, SEE CONSTRUCTION STAKING TAB SAPACER DAMPER TO BE AD∨ISED BY	LE.	
SAPACER DAMPER TO BE ADVISED BY	ĻE.	
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SAPACER DAMPER TO BE ADVISED BY		CANADA
NSS, SEE CONSTRUCTION STAKING TAB SAPACER DAMPER TO BE ADVISED BY TER, U.N.O.		CANADA
SAPACER DAMPER TO BE ADVISED BY TER, U.N.O. NEXTERA 5-PACK TRANSMISSION LINE	NEXTE ENERG ENERG Sed Fourteenth Markham, On., Email: chimax	CANADA
SAPACER DAMPER TO BE ADVISED BY TER, U.N.O. NEXTERA 5-PACK TRANSMISSION LINE CT 115kV TRANSMISSION LINE		CANADA
SAPACER DAMPER TO BE ADVISED BY TER, U.N.O. NEXTERA 5-PACK TRANSMISSION LINE CT 115kV TRANSMISSION LINE LE CONDUCTOR CONFIGURATION	Chimax Biggingering Con Biggingering Con Bigg	CANADA
NEXTERA 5-PACK TRANSMISSION LINE TER, U.N.O. NEXTERA 5-PACK TRANSMISSION LINE T 115kV TRANSMISSION LINE LE CONDUCTOR CONFIGURATION ANGLE (60 - 90°) FRAMING DRAWING P	NEXTE ENERG ENERG Sed Fourteenth Markham, On., Email: chimax	CANADA CANADA Inc. Jar 0.49 chimax.ca

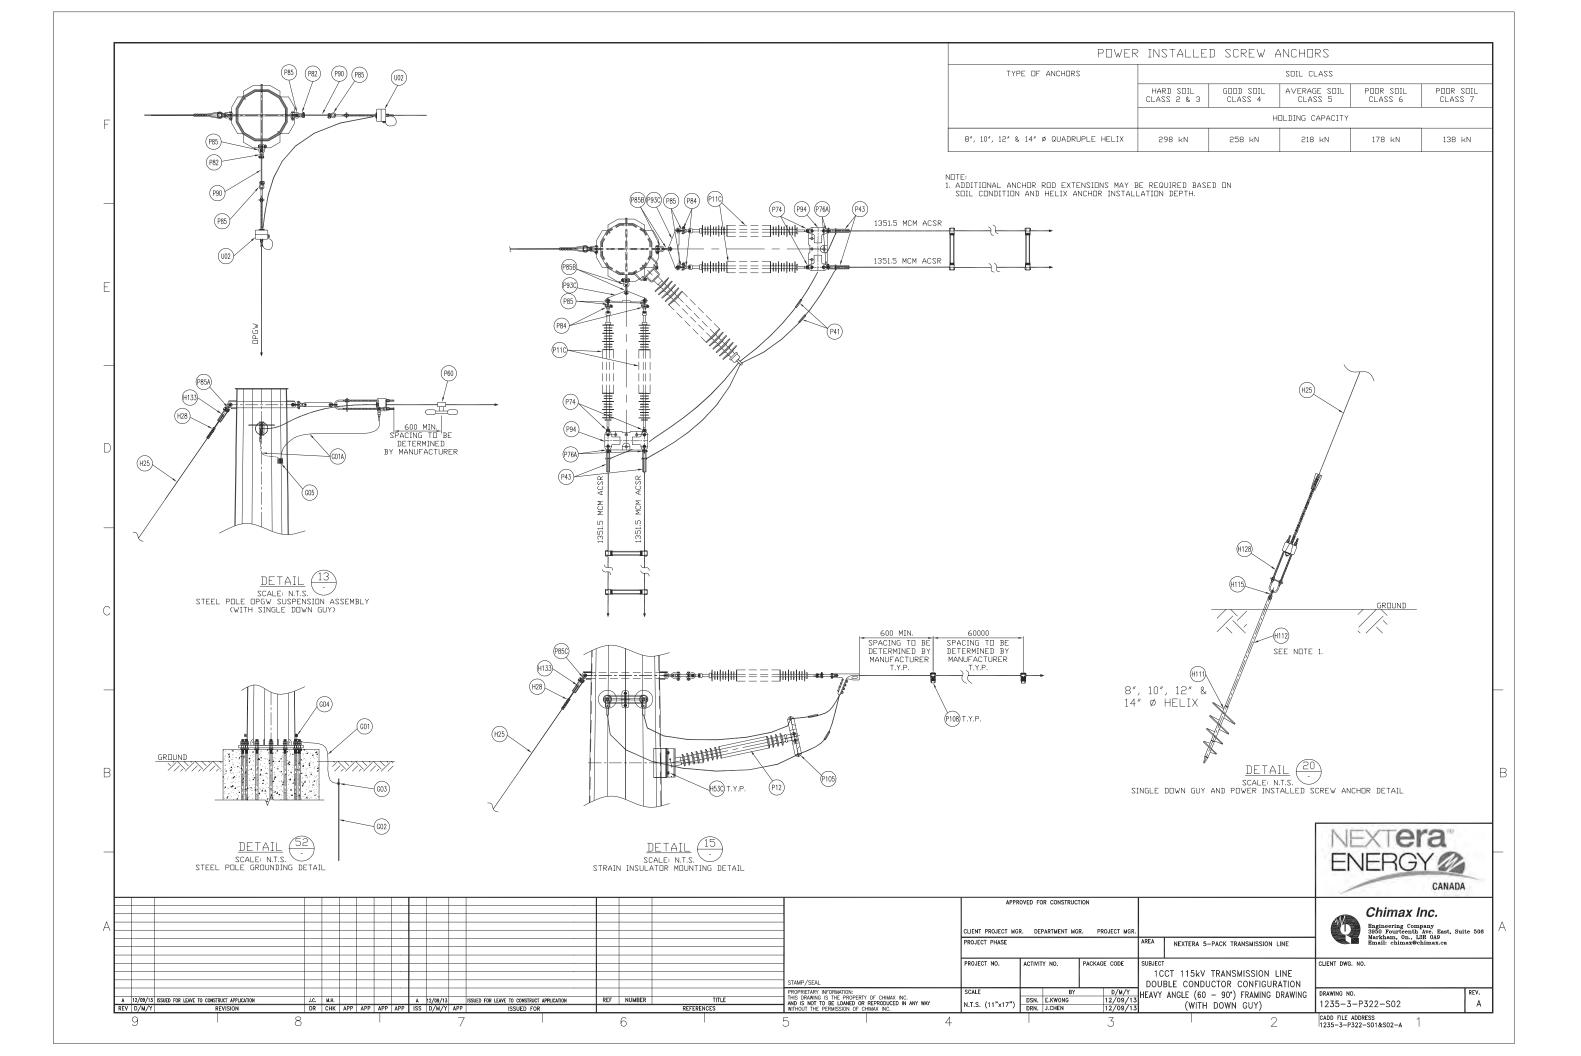

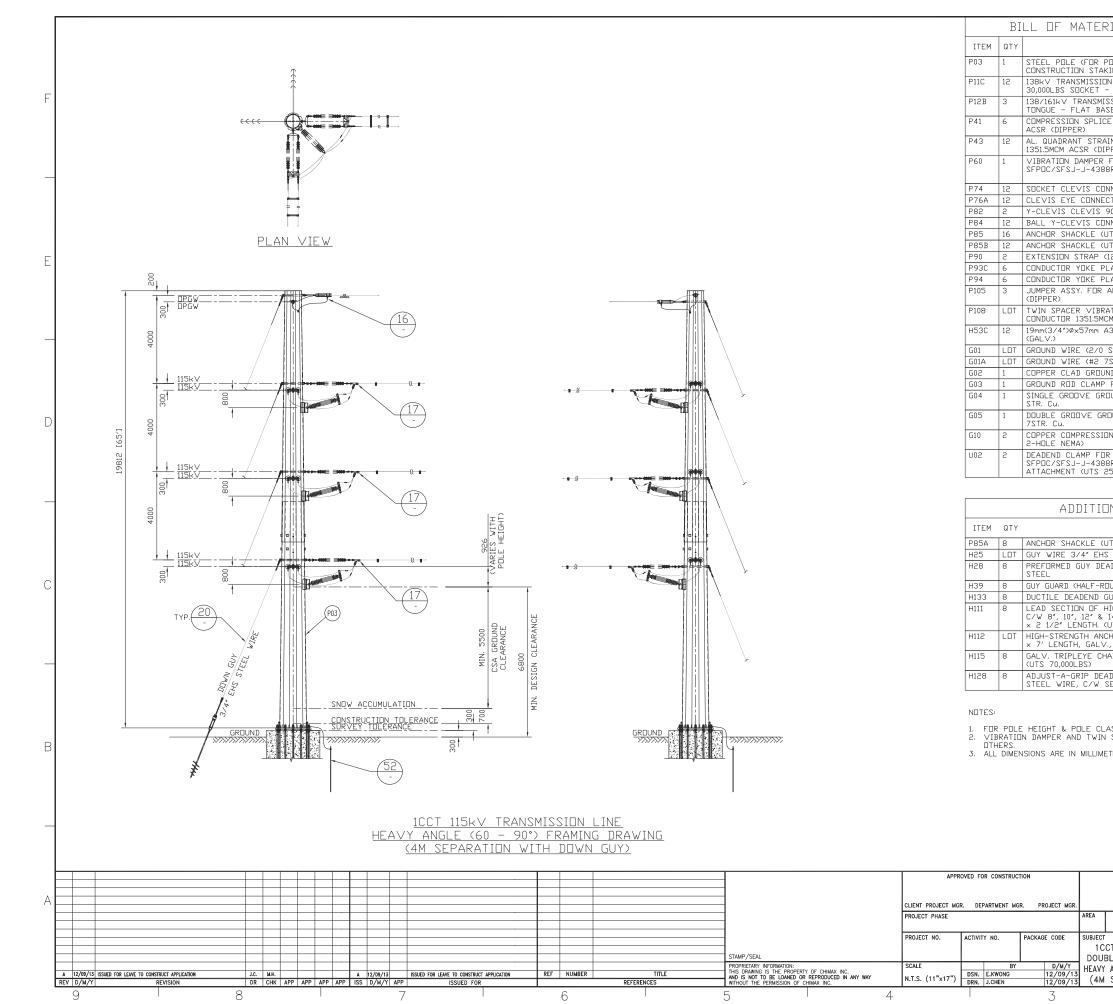


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DESCRIPTION	MANUFACTURER/NO	REMARKS	
POLE LENGTH & CLASS, SEE	OR EQUIVALENT	KEINKKS	
(ING TABLE) IN LINE SUSPENSION INSULATOR (SML	NGK-LOCKE		
- BALL ENDS) SSION LINE POST INSULATOR (DROP	PART #301-SC390-SJ NGK-LOCKE		F
SE)	PART #L2-SN371-18		ľ
E FOR AL. CONDUCTOR 1351.5MCM	HUBBELL A151561		
IN CLAMP FOR AL CONDUCTOR PPER) (UTS 35,000LBS)	HUBBELL SD155N		
FOR 48 FIBERS OPGW (REF: 8R2)		STOCKBRIDGE TYPE OR SPIRAL	1
NNECTOR (30,000LBS UTS)	HUBBELL SC301	TYPE (T.B.A.)	F
CTER (UTS 30,000LBS)	HUBBELL CE054125		
90 DEG. CONNECTOR (UTS 30,000LBS) NNECTOR (UTS 30,000LBS)	HUBBELL YCC3090 HUBBELL YBC30		
JTS 40,000LBS>	HUBBELL AS35BNK		
JTS 60,000LBS) 12″ LENGTH, UTS 30,000LBS)	HUBBELL AS50WBNK HUBBELL ES30781912		
LATE (UTS 60,000LBS)	HUBBELL YPD60183771		E
LATE (UTS 30,000LBS)	HUBBELL YPR30187221		1
AL. CONDUCTOR 1351.5MCM ACSR	HUBBELL 2717243001		
ATION DAMPER FOR TWO AL. CM ACSR (DIPPER) (18″ SPACING)	PFISTERER 182 952-195		
A325 BOLT + 2×FLAT WASHER + NUT			
STR, Cu.)			1
7STR. Cu.) ND RDD, 3/4″ DIA. 10′ LENGTH		Т.В.А.	1
FOR 3/4" DIA. TO 2/0 STR. Cu.	HUBBELL C2030345		
OUND CLAMP FOR #4 SOL TO 4/0	HUBBELL GC141AG2		
OUND CLAMP FOR #2 7STR. Cu. & #2	HUBBELL GC143G1		D
IN TERMINAL FOR #2 7STR. Cu. (C/W	HUBBELL BCL018B		
R 48 FIBERS DPGW (REF: 8R2), C/W HARDWARE FDR TERMINAL	PLP 2801309		
25,000LBS>			
			L
INAL PARTS FOR SINGLE			
DESCRIPTION	MANUFACTURER/NO OR EQUIVALENT	REMARKS	
JTS 60,000LBS> S GALVANIZED STEEL	HUBBELL AS50BNK		
ADEND FOR 3/4" EHS GALVANIZED	PLP BG-2112		
JUND MARKER 2″ DIA. × 8′ LENGTH)	HUBBELL 96PBG-2Y	AS REQ'D	С
GUY THIMBLE CLE∨IS (UTS 60,000LBS)	HUBBELL DDT12		
HIGH-STRENGTH SS ANCHORS (GALV.), 14" DIA. HELIX AND 1 1/2" DIA. ROD	HUBBELL T1100521		
UTS 70,000LBS) CHOR ROD EXTENSION, 1 1/2″ DIA. ROD	HUBBELL C1100389	AS REQ'D	
., (UTS 70,000LBS)			
AIN SHACKLE, FOR 1 1/2″ DIA. ROD	HUBBELL C1100574		$\vdash$
ADEND GRIPS FOR 3/4" EHS GALV. SERVING SLEEVE (UTS 58,000LBS)	HUBBELL 34GA18S		
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ASS, SEE CONSTRUCTION STAKING TAB SAPACER DAMPER TO BE ADVISED BY	зLЕ.		-
ASS, SEE CONSTRUCTION STAKING TAB SAPACER DAMPER TO BE ADVISED BY TER, U.N.O.	jLE.		B
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	NEXT <b>e</b> ENERG		
	Chimax	Inc.	
	Chimax		
TER, U.N.O.	Chimax	Inc.	
NEXTERA 5-PACK TRANSMISSION LINE	NEXTE ENERG ENERG	Inc.	
NEXTERA 5-PACK TRANSMISSION LINE CT 115kV TRANSMISSION LINE CT 115kV TRANSMISSION LINE BLE CONDUCTOR CONFIGURATION ANGLE (60 - 90°) FRAMING DRAWING	ILENT DWG. NO.	Inc. npany Rest, Suite 506 LaR 0.09 chimax.ca	В —
NEXTERA 5-PACK TRANSMISSION LINE CT 115kV TRANSMISSION LINE CT 115kV TRANSMISSION LINE BLE CONDUCTOR CONFIGURATION ANGLE (60 – 90') FRAMING DRAWING SEPARATION WITH DOWN GUY)	ILIENT DWG. NO. 235–3–P323–S01	Inc. npany i Ave. East, Suite 506 GSR 0.49 obimax.ca	
NEXTERA 5-PACK TRANSMISSION LINE CT 115kV TRANSMISSION LINE CT 115kV TRANSMISSION LINE CC 115kV TRANSMISSION LI	ILENT DWG. NO.	Inc. npany Rest, Suite 506 LaR 0.09 chimax.ca	

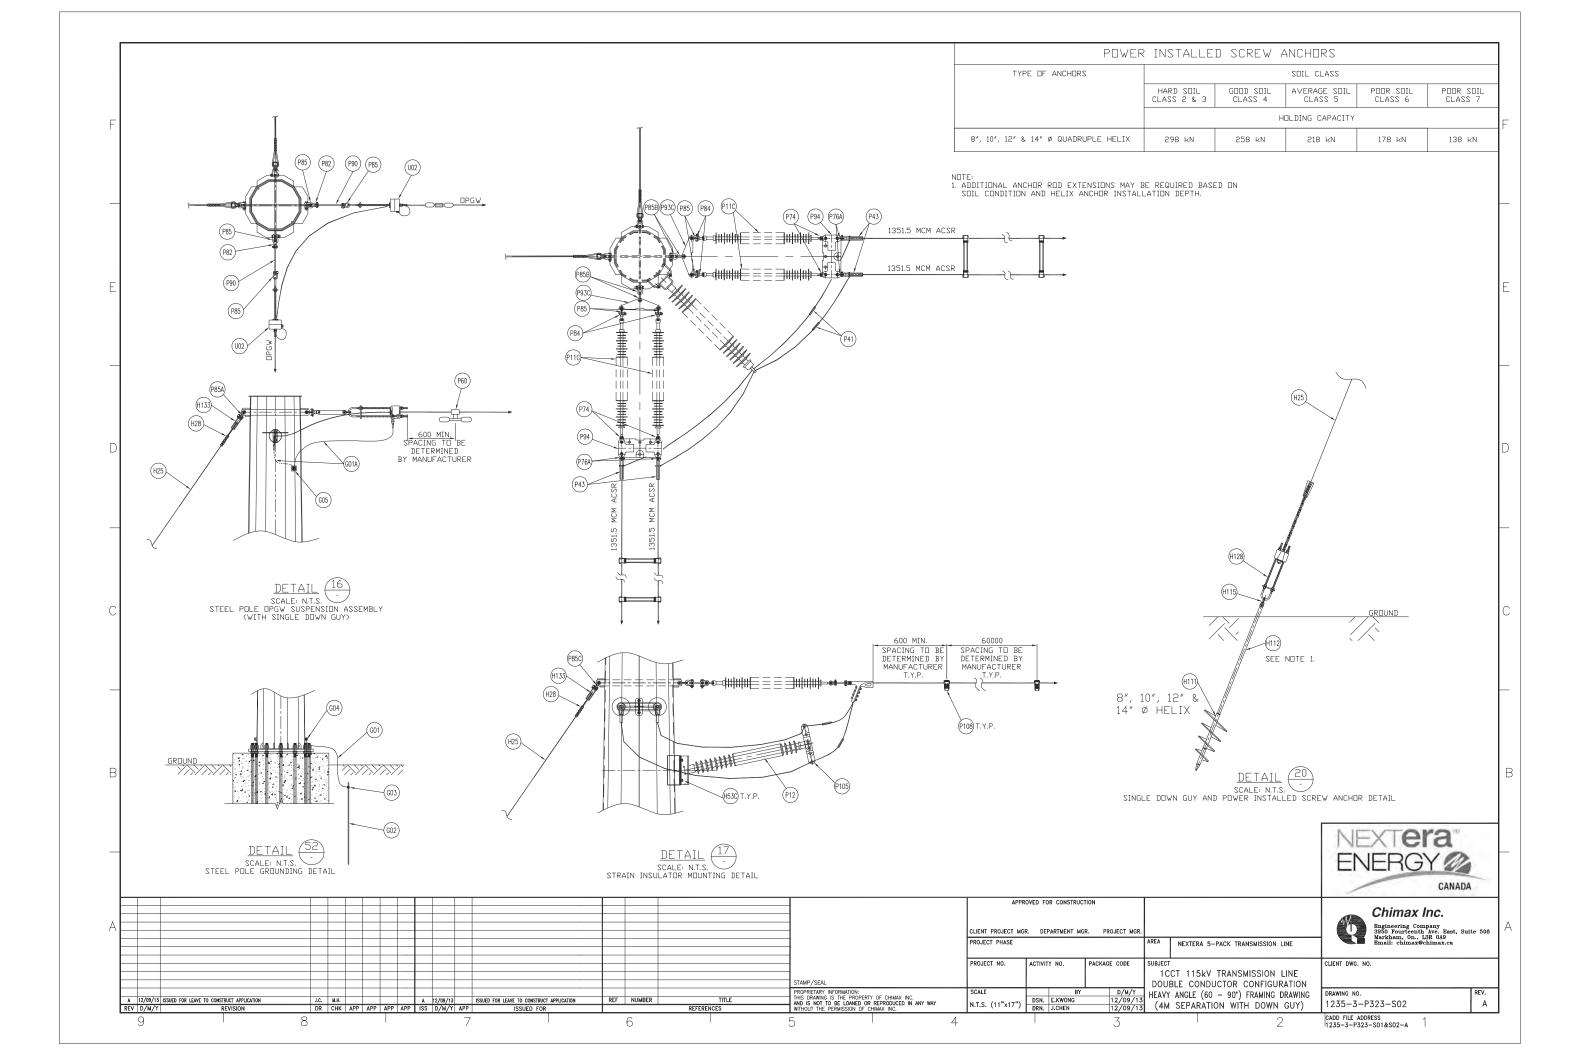


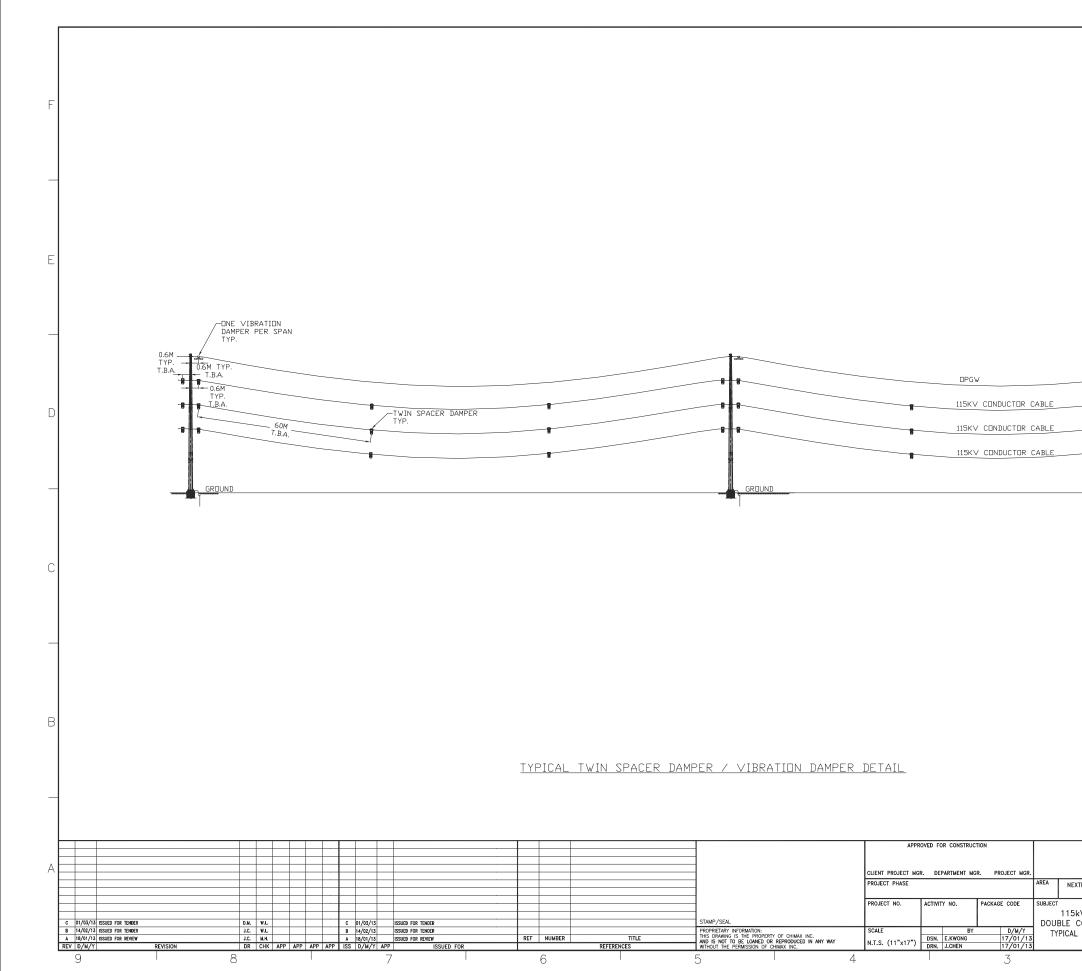


CLIENT DWG. NO.			
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TERA 5-PACK TRANSMISSION LINE       CLIENT DWG. NO.         KV TRANSMISSION LINE       CLIENT DWG. NO.	•	GROUND	_
TERA 5-PACK TRANSMISSION LINE       CLIENT DWG. NO.       CLIENT DWG. NO.       Rev.       C         KV TRANSMISSION LINE       CLIENT DWG. NO.       Rev.       C       C       Rev.       C			С
TERA 5-PACK TRANSMISSION LINE       CLIENT DWG. NO.       CLIENT DWG. NO.       Rev.       C         KV TRANSMISSION LINE       CLIENT DWG. NO.       Rev.       C       C       Rev.       C			
TERA 5-PACK TRANSMISSION LINE       Chimax Inc.       A         KV TRANSMISSION LINE       CLIENT DWG. NO.       Regimeering Company Shedge Pourteening Area Bart, Suite 508 Remail: chimaxechimax.ca       A         KV TRANSMISSION LINE       CLIENT DWG. NO.       C       A         KV TRANSMISSION LINE       CLIENT DWG. NO.       Rev.       C         CONDUCTOR CONFIGURATION DAMPER DETAIL       DRAWING NO.       Rev.       C			В
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TWIN SPACER / VIBRATION     DRAWING NO.     REV.       DAMPER DETAIL     1235-2-P130     C	V TRANSMISSION LINE	Regineering Company 3856 Fourteenth Ave. East, Suite 506 Markham, On., L3R 0A9 Email: chimar@chimax.ca	A
	TWIN SPACER / VIBRATION DAMPER DETAIL	1235-2-P130 C	]

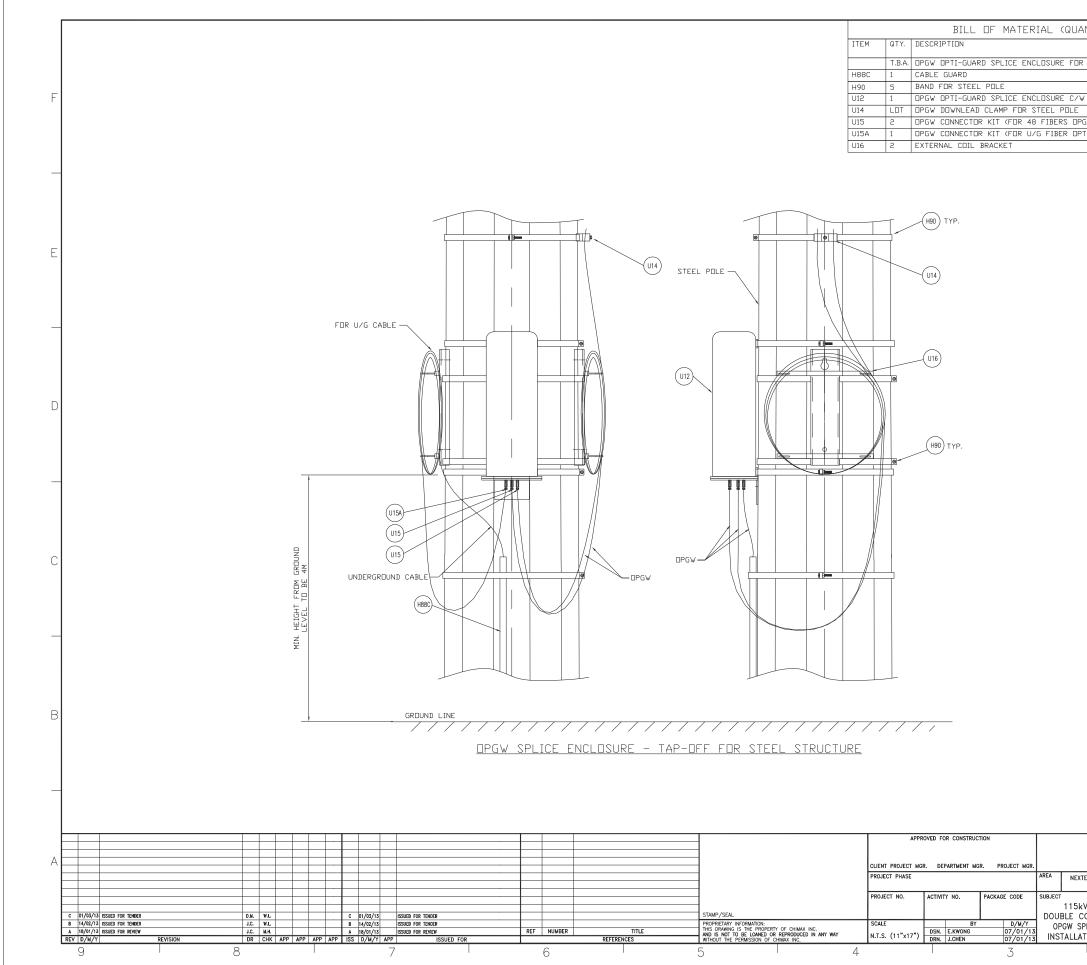


IIIICS SILLWIN F	MANUFACTURER/ND. DR	REMARKS	_
	EQUIVALENT		
STEEL STRUCTURE	HUBBELL 6535		-
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BAND MOUNTING KIT	AFL DG03 AFL FDDAB5B5A	T.B.A.	F
/)	HEL FULADJOJA	T.B.A.	-
CS CABLE>		T.B.A.	
	AFL CB-44		
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		CANADA	
	Chima	x Inc.	
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5-PACK TRANSMISSION LIN	Markham, Or Email: chim	Company enth Ave. East, Suite 50 n., L3R 0A9 ax@chimax.ca	
	CLIENT DWG. NO.		-
TRANSMISSION LINE			
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CE ENCLOSURE-TAP-OF	F DRAWING NO.	REV. C	

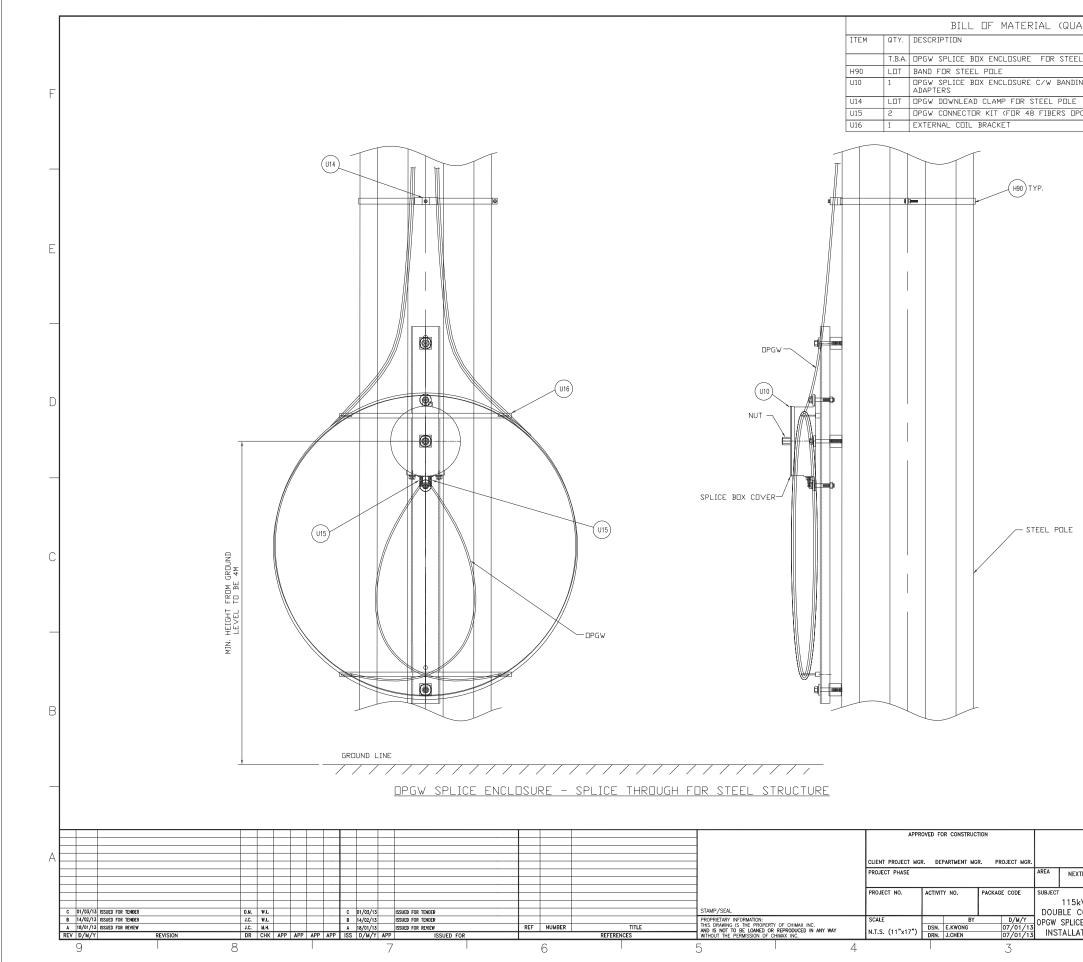


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L STRUCTURE	EQUIVALENT	REPIARKS	
		T.B.A.	
NG AND STEEL TOWER	AFL SB-01		F
PGW)	AFL FDDAB5B5A	T.B.A.	-
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TERA 5-PACK TRANSMISSION LINE	Markham, On Email: chima	Company nth Ave. East, Suite 506 a., L3R 0A9 x@chimax.ca	
kV TRANSMISSION LINE	CLIENT DWG. NO.		1
CONDUCTOR CONFIGURAT		REV.	-
ATION & ASSEMBLY DETA	IL 1235-2-P132	С	
2	CADD FILE ADDRESS 1235-2-P132-C	1	

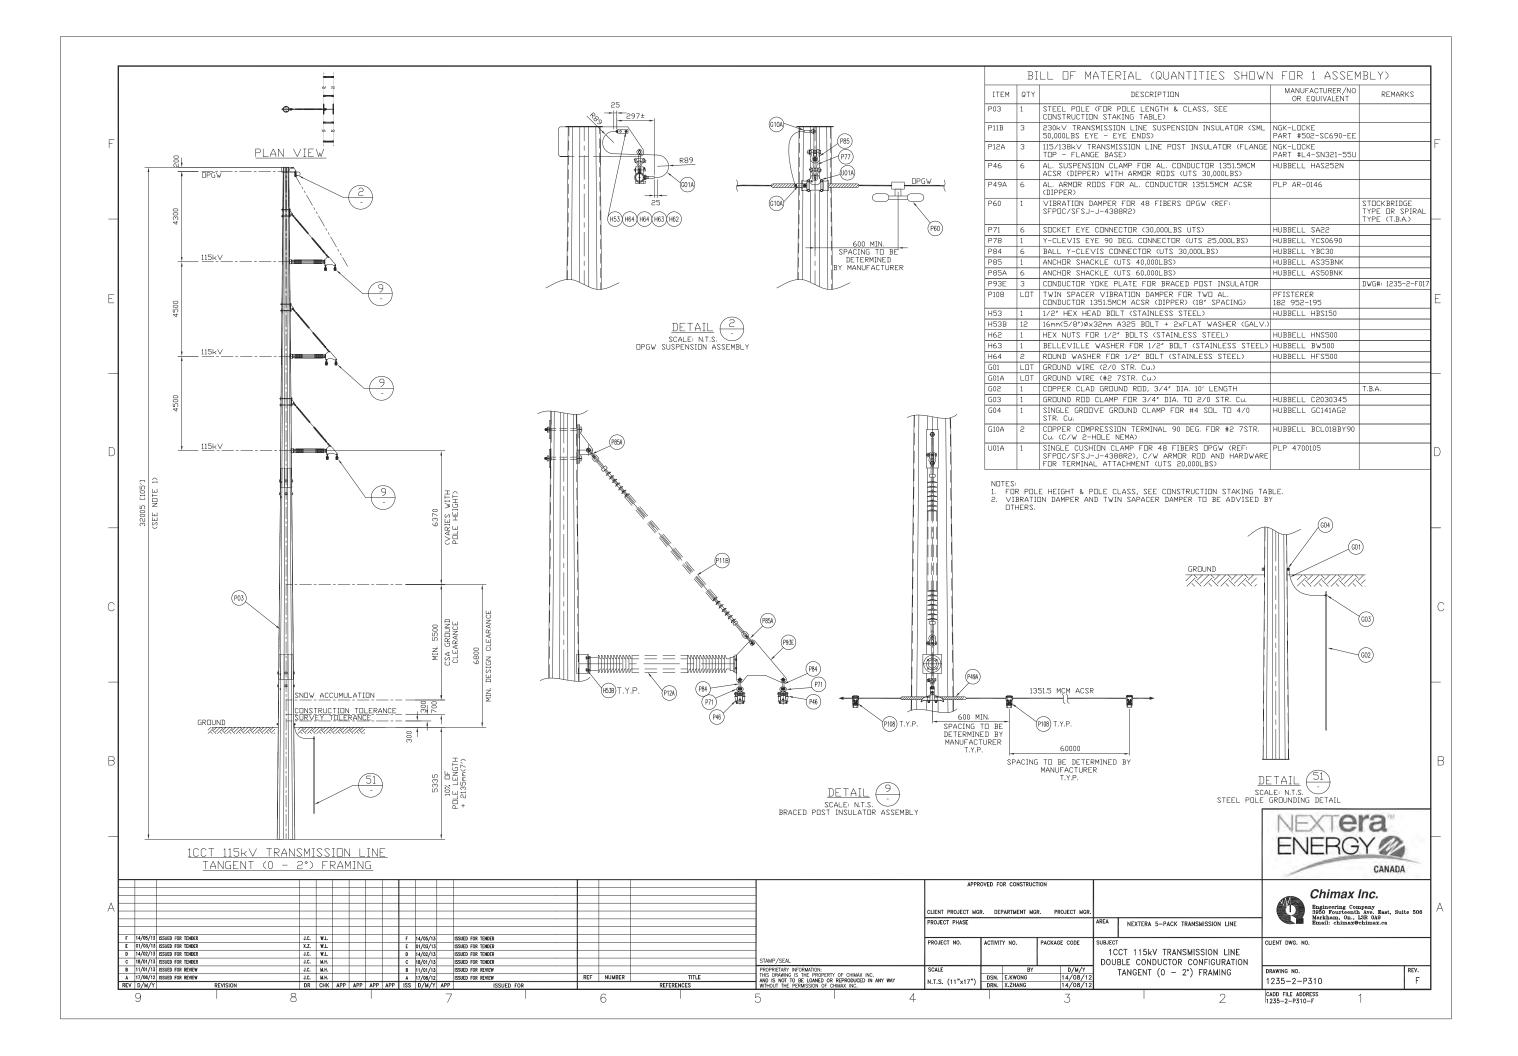

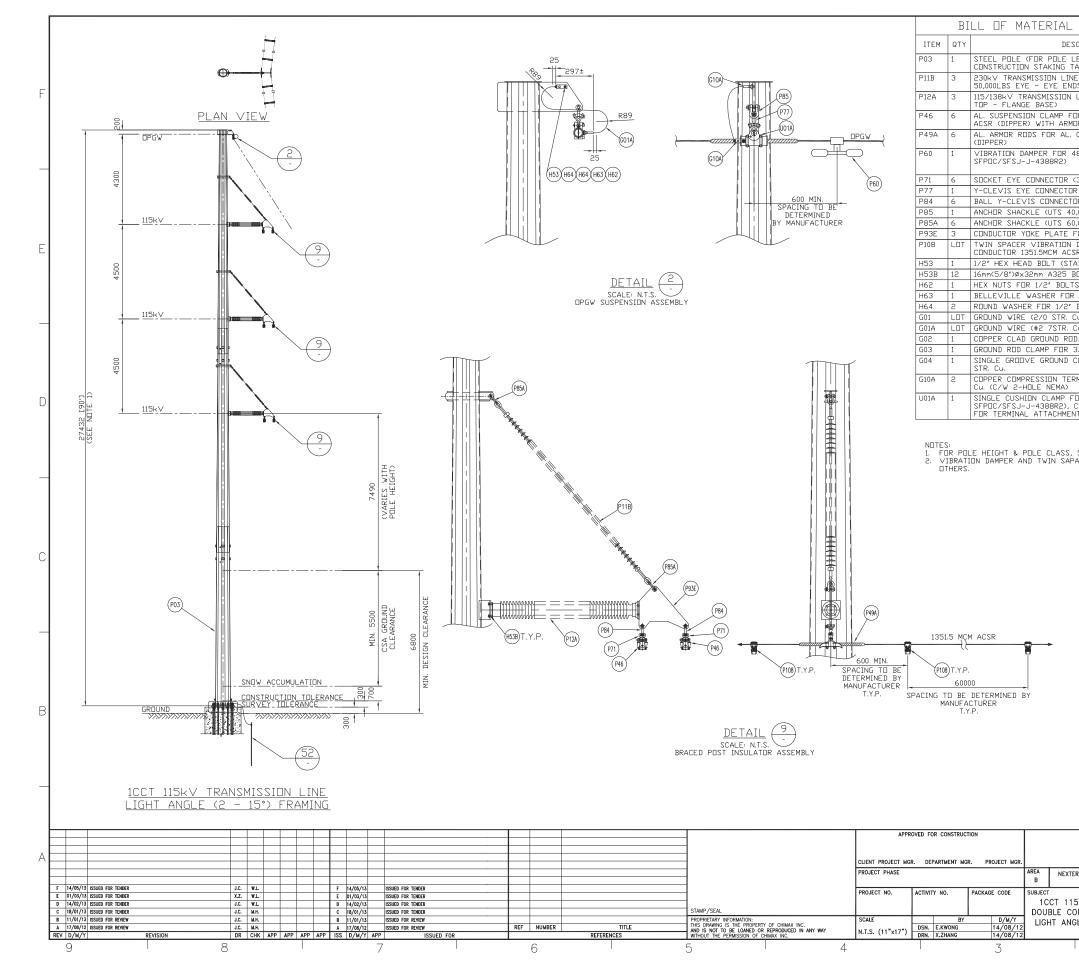

SCRIPTION	MANUFACTURER/NO	REMARKS	1
ENGTH & CLASS, SEE	OR EQUIVALENT		
ABLE) E_SUSPENSION INSULATOR (SML	NGK-LOCKE		
IS) LINE POST INSULATOR (FLANGE			F
R AL. CONDUCTOR 1351.5MCM	PART #L4-SN321-55U HUBBELL HAS252N		
IR RODS (UTS 30,000LBS)	PLP AR-0146		
CONDUCTOR 1351.5MCM ACSR	PLP AR-UI46		
8 FIBERS DPGW (REF:		STOCKBRIDGE TYPE OR SPIRAL	
30,000LBS UTS)	HUBBELL SA22	TYPE (T.B.A.)	
(UTS 25,000LBS)	HUBBELL YCS06		
IR (UTS 30,000LBS) ,000LBS)	HUBBELL YBC30 HUBBELL AS35BNK		
,000LBS)	HUBBELL ASSOBNK		
OR BRACED POST INSULATOR		DWG#: 1235-2-F017	
DAMPER FOR TWO AL. R (DIPPER) (18" SPACING)	PFISTERER 182 952-195		E
AINLESS STEEL)	HUBBELL HBS150		
BOLT + 2×FLAT WASHER (GALV. S (STAINLESS STEEL)	HUBBELL HNS500		
1/2" BOLT (STAINLESS STEEL			
BOLT (STAINLESS STEEL)	HUBBELL HFS500		
Cu.) Cu.)			$\vdash$
D, 3/4" DIA. 10' LENGTH		T.B.A.	
3/4" DIA. TO 2/0 STR. Cu.	HUBBELL C2030345		
CLAMP FOR #4 SOL TO 4/0	HUBBELL GC141AG2		
MINAL 90 DEG. FOR #2 7STR.	HUBBELL BCL018BY90		1
OR 48 FIBERS OPGW (REF:	PLP 4700105		D
C/W ARMOR ROD AND HARDWARE IT (UTS 20,000LBS)			
SEE CONSTRUCTION STAKING T ACER DAMPER TO BE ADVISED			_
	BY		
	BY	901)	 C
		a)	C
ACER DAMPER TO BE AD∨ISED		90) 	C
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ACER DAMPER TO BE AD∨ISED			C
GROUND	BY		 
GRUUND	DE TAIL 52 CALE: NT.S.		
GRUUND	DETAIL (52)		
GRUUND	DE TAIL 52 CALE: NT.S.		
GRUUND	DE TAIL 52 CALE: NT.S.		
GRUUND	DE TAIL 52 CALE: NT.S.		
ACER DAMPER TO BE ADVISED	DE TAIL 52 CALE: NT.S.		
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GROUND	BY DETAIL CALE: N.T.S. CALE: N.T.S. CALE: N.T.S. Chimax	CANADA	
ACER DAMPER TO BE ADVISED	BY	CANADA	
GRUUND GRUUND GRUUND STEEL POLE STEEL POLE STEEL POLE SKV TRANSMISSION LINE SkV TRANSMISSION LINE SkV TRANSMISSION LINE SLE (2 – 15°) FRAMING	BY	Canada Canada Canada Inc. apany Bast, Suite 508 chimax.es	
GRUUND GRUUND GRUUND STEEL POLE STEEL POLE STEEL POLE SKV TRANSMISSION LINE SkV TRANSMISSION LINE	BY	CANADA (602) (602) (602) (602) (602) (602) (602) (602) (602) (602) (602) (602) (602) (602) (602) (602) (603) (602) (603) (602) (603) (602) (603) (602) (603) (602) (603) (602) (603) (602) (602) (603) (602) (603) (602) (603) (602) (603) (602) (603) (602) (	

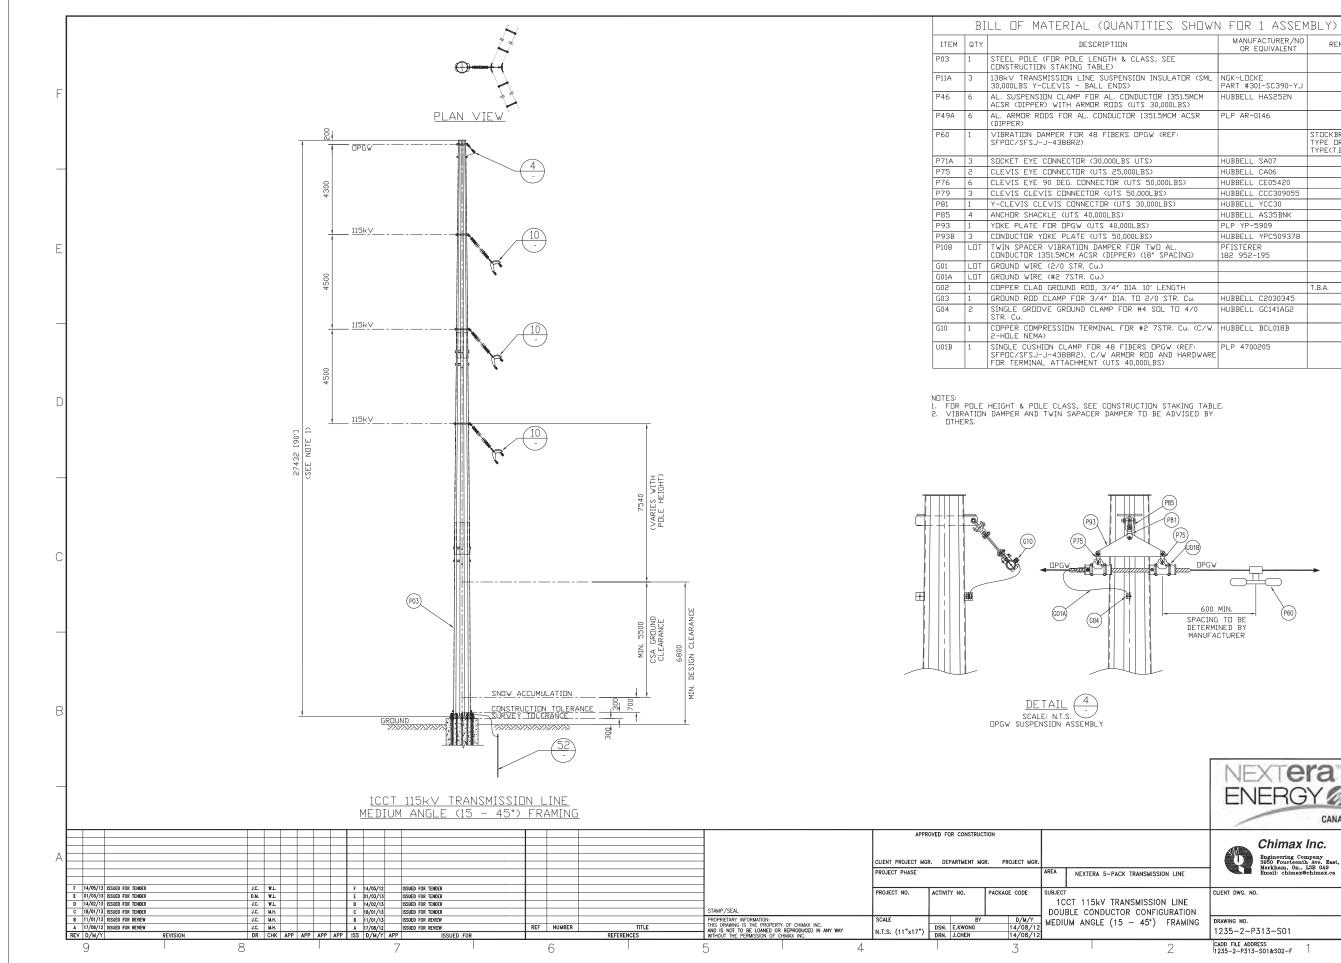


48 FIBERS OPGW (REF:		STOCKBRIDGE TYPE OR SPIRAL TYPE(T.B.A.)	
(30,000LBS UTS)	HUBBELL SA07		1
(UTS 25,000LBS)	HUBBELL CA06		1
INNECTOR (UTS 50,000LBS)	HUBBELL CE05420		
TOR (UTS 50,000LBS)	HUBBELL CCC309055		
IECTOR (UTS 30,000LBS)	HUBBELL YCC30		
40,000LBS)	HUBBELL AS35BNK		
(UTS 40,000LBS)	PLP YP-5909		
(UTS 50,000LBS)	HUBBELL YPC509378		
N DAMPER FOR TWO AL. CSR (DIPPER) (18″ SPACING)	PFISTERER 182 952-195		
			1
. Cu.>			
CDD, 3/4" DIA. 10' LENGTH		T.B.A.	1
2 3/4″ DIA. TO 2/0 STR. Cu.	HUBBELL C2030345		
CLAMP FOR #4 SOL TO 4/0	HUBBELL GC141AG2		1
ERMINAL FOR #2 7STR. Cu. (C/W	HUBBELL BCL018B		
FOR 48 FIBERS OPGW (REF:	PLP 4700205		
, C/W ARMOR ROD AND HARDWARE			
ENT (UTS 40,000LBS)			
P3 P3 P3 P3 P75 P75 P75 DPGW 600 SPACING DETERMI MANUFA	MIN. j TU BE INED BY	→	C
4 - MBLY			В
	NEXT <b>E</b>	ra	
		CANADA	
	Chimax 🖉		
KTERA 5-PACK TRANSMISSION LINE	Engineering Con 3950 Fourteenth Markham, On., 1 Email: chimax	npany n Ave. East, Suite 508 L3R 0A9 chimax.ca	A
c	LIENT DWG. NO.		1
15kV TRANSMISSION LINE			
CONDUCTOR CONFIGURATION		1 000/	
	RAWING NO.	REV.	
	235-2-P313-S01	F	
2 1	ADD FILE ADDRESS 235-2-P313-S01&S02-F	1	

MANUFACTURER/NO OR EQUIVALENT


HUBBELL HAS252N

PLP AR-0146


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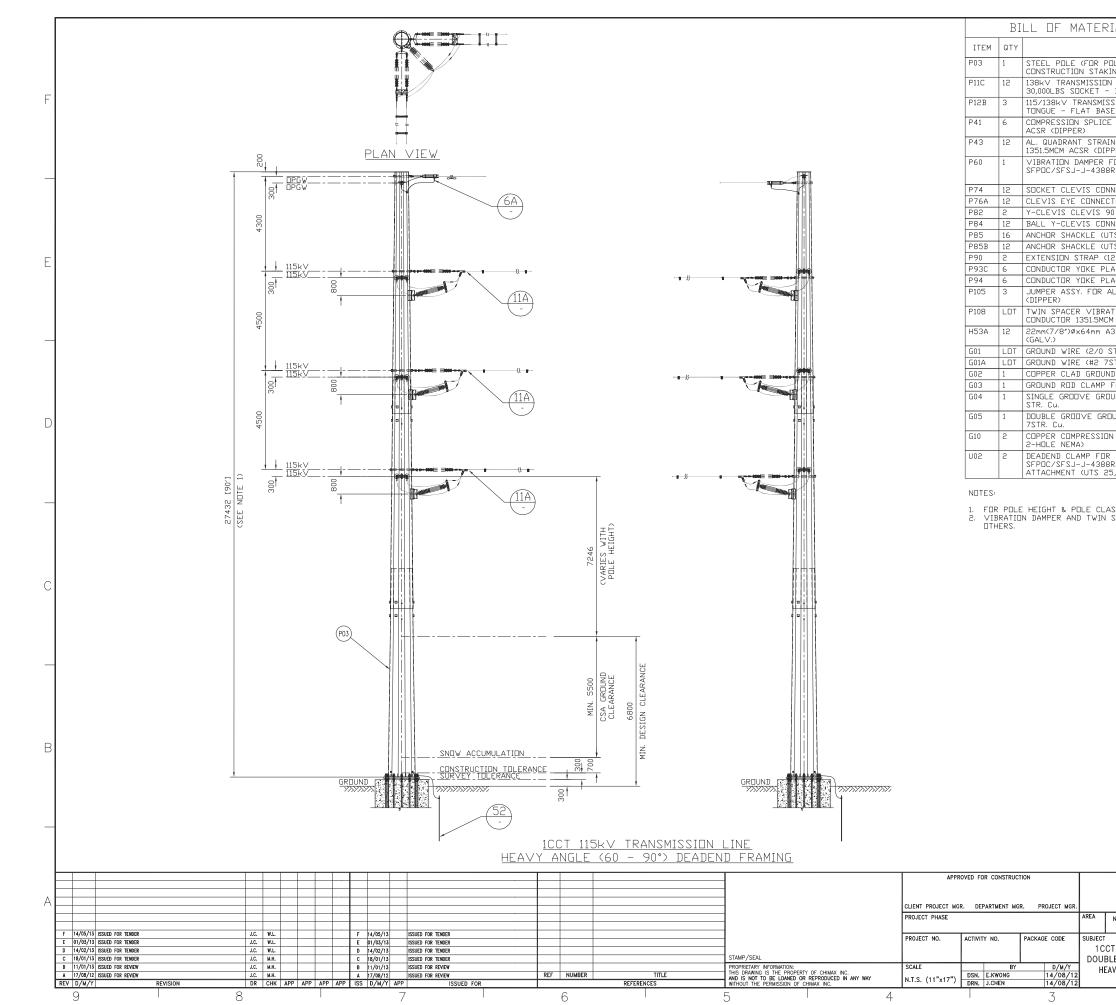

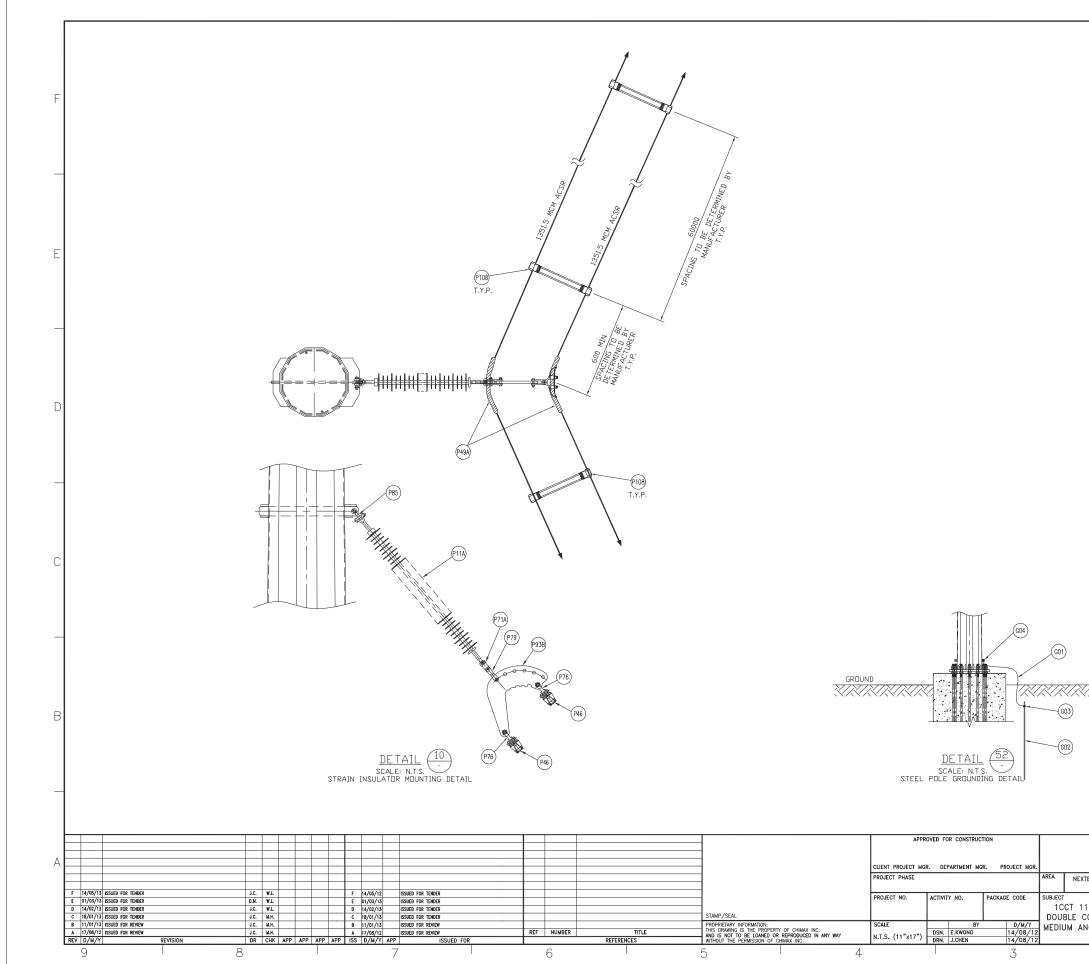
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		С
		_
72		
		В
	NEXT <b>era</b> "	
	ENERGY	-
	CANADA	
TERA 5-PACK TRANSMISSION LINE	CLIENT DWG. NO.	A
15kV TRANSMISSION LINE CONDUCTOR CONFIGURATION NGLE (15 - 45°) FRAMING	DRAWING NO. 1235-2-P313-S02 F	
2	CADD FILE ADDRESS 1235-2-P313-S01&S02-F	•

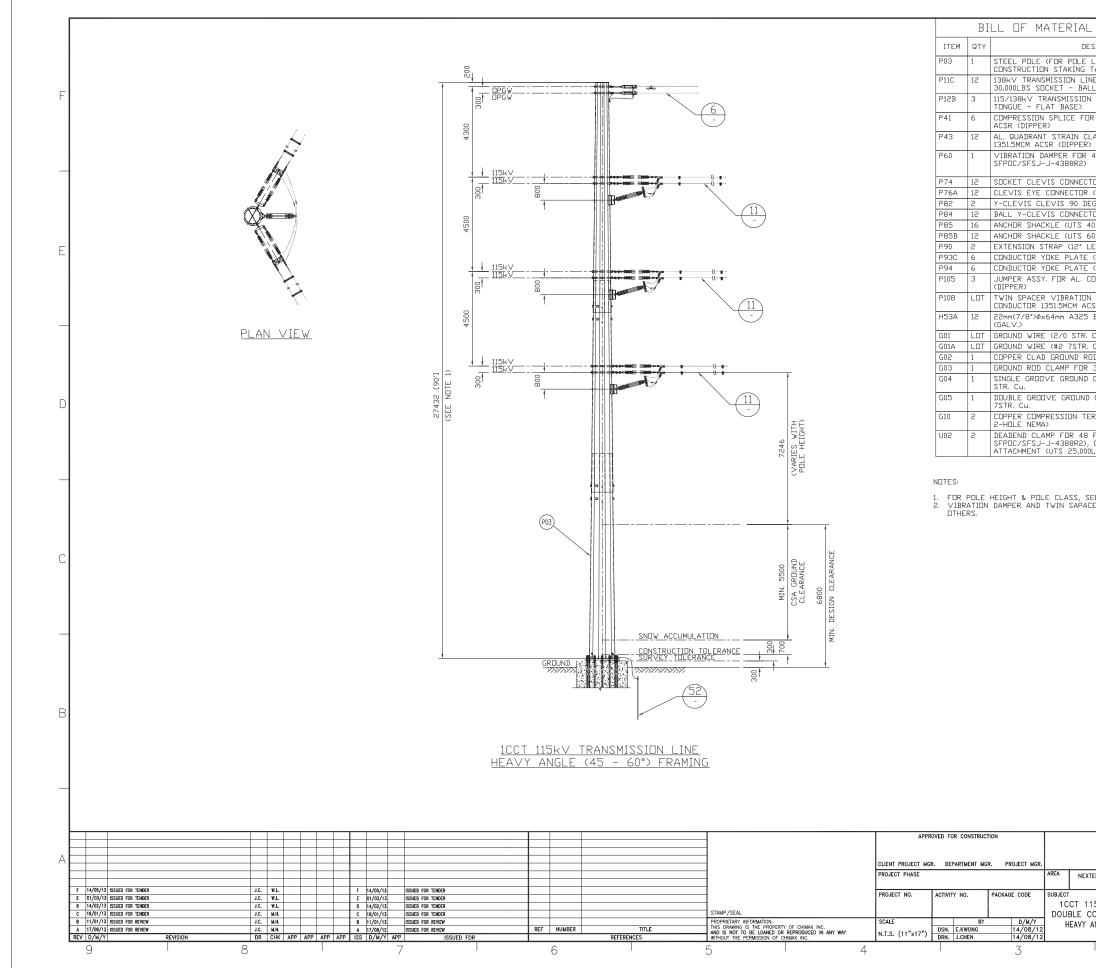



. (QUANTITIES SHOWI	N FOR 1 ASSEM	1BLY)	
SCRIPTION	MANUFACTURER/NO OR EQUIVALENT	REMARKS	1
LENGTH & CLASS, SEE	OR EQUIVALENT		
TABLE) NE SUSPENSION INSULATOR (SML	NGK-LOCKE		
L ENDS)	PART #301-SC390-SJ		F
LINE POST INSULATOR (DROP	NGK-LOCKE PART #L4-SN321-18		Ľ
R AL. CONDUCTOR 1351.5MCM	HUBBELL A151561		1
AMP FOR AL CONDUCTOR	HUBBELL SD155N		
48 FIBERS DPGW (REF)		STOCKBRIDGE	
TO TIDENS EN GW (REF)		TYPE OR SPIRAL	
TER (30,000LBS UTS)	HUBBELL SC301	TIFE (L.B.A.2	
(UTS 30,000LBS)	HUBBELL CE054125		
G. CONNECTOR (UTS 30,000LBS)	HUBBELL YCC3090 HUBBELL YBC30		
0,000LBS>	HUBBELL AS35BNK		
0,000LBS>	HUBBELL AS50WBNK		
ENGTH, UTS 30,000LBS) (UTS 60,000LBS)	HUBBELL ES30781912 HUBBELL YPD60183771		E
(UTS 30,000LBS)	HUBBELL YPR30187221		
UNDUCTOR 1351.5MCM ACSR	HUBBELL 2717243001		1
DAMPER FOR TWO AL.	PFISTERER		
SR (DIPPER) (18" SPACING) BOLT + 2×FLAT WASHER + NUT	182 952-195		
BULI + EXFLAI WASHER + NUI			$\vdash$
Cu.)			
Cu.) ]D, 3/4″ DIA. 10′ LENGTH		T.B.A.	
3/4″ DIA. TO 2/0 STR. Cu.	HUBBELL C2030345		
CLAMP FOR #4 SOL TO 4/0	HUBBELL GC141AG2		
CLAMP FOR #2 7STR. Cu. & #2	HUBBELL GC143G1		
RMINAL FOR #2 7STR. Cu. (C/W	HUBBELL BCL018B		D
FIBERS OPGW (REF: C/W HARDWARE FOR TERMINAL	PLP 2801309		
LBS)			
			С 
15kV TRANSMISSION LINE CONDUCTOR CONFIGURATION ANGLE (45 – 60°) FRAMING	Chimax Chimax	CANADA CANADA CANADA Data Party Raset, Suite 506 chimax.ce	A
2	CADD FILE ADDRESS 1235-2-P314-S01&S02-F	1	



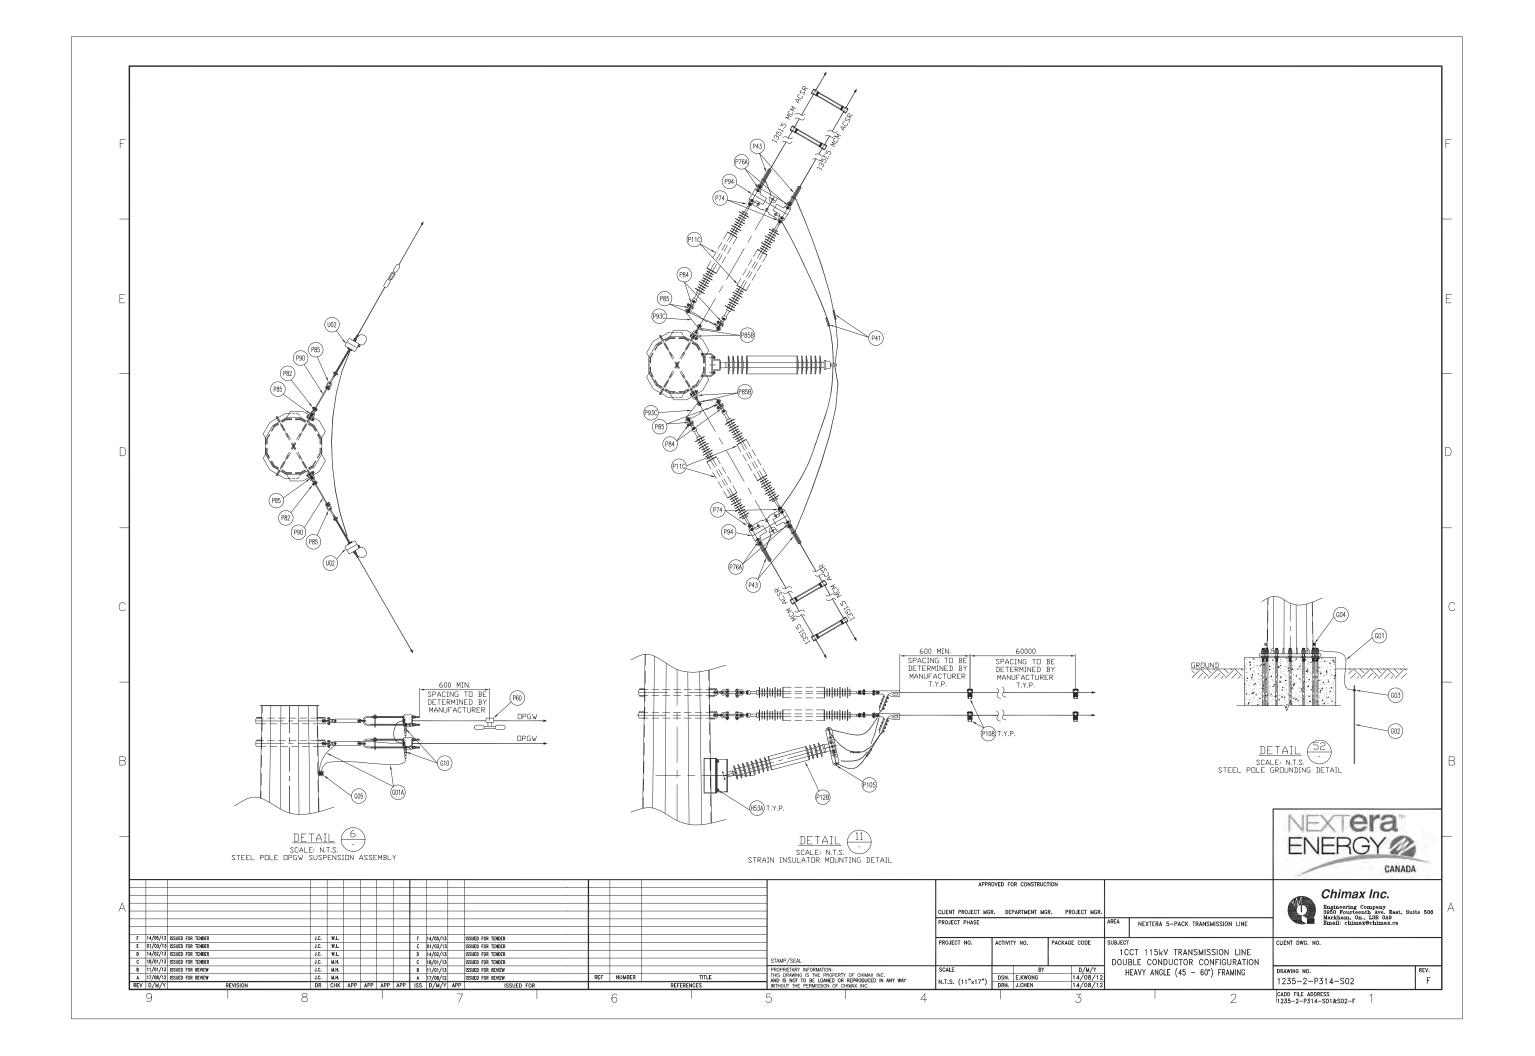



			1
IAL (QUANTITIES SHOWN	N FOR 1 ASSEM	1BLY)	
DESCRIPTION	MANUFACTURER/NO OR EQUIVALENT	REMARKS	
DLE LENGTH & CLASS, SEE	OK EQOIVALENT		
ING TABLE) N LINE SUSPENSION INSULATOR (SML	NGK-LOCKE		
BALL ENDS)	PART #301-SC390-SJ		
SION LINE POST INSULATOR (DROP E)	NGK-LOCKE PART #L4-SN321-18		F
E FOR AL. CONDUCTOR 1351.5MCM	HUBBELL A151561		
N CLAMP FOR AL CONDUCTOR PER) (UTS 35,000LBS)	HUBBELL SD155N		
FOR 48 FIBERS OPGW (REF:		STOCKBRIDGE	
R2)		TYPE OR SPIRAL TYPE (T.B.A.)	$\vdash$
INECTOR (30,000LBS UTS)	HUBBELL SC301		
TER (UTS 30,000LBS) 0 DEG. CENNECTER (UTS 30,000LBS)	HUBBELL CE054125 HUBBELL YCC3090		
INECTOR (UTS 30,000LBS)	HUBBELL YBC30		
TS 40,000LBS>	HUBBELL AS35BNK		
TS 60,000LBS)	HUBBELL AS50WBNK		
2" LENGTH, UTS 30,000LBS) ATE (UTS 60,000LBS)	HUBBELL ES30781912 HUBBELL YPD60183771		E
ATE (UTS 30,000LBS)	HUBBELL YPR30187221		
AL. CONDUCTOR 1351.5MCM ACSR	HUBBELL 2717243001		
	DEISTEDED		
TION DAMPER FOR TWO AL. M ACSR (DIPPER) (18" SPACING)	PFISTERER 182 952-195		
325 BOLT + 2×FLAT WASHER + NUT			
STR, Cu.)			
STR. Cu.)			
ID ROD, 3/4" DIA. 10' LENGTH		T.B.A.	
FOR 3/4" DIA. TO 2/0 STR. Cu. IUND CLAMP FOR #4 SOL TO 4/0	HUBBELL C2030345		
IOND CLAMP FOR #4 SOL TO 470	HUBBELL GC141AG2		
JUND CLAMP FOR #2 7STR. Cu. & #2	HUBBELL GC143G1		D
N TERMINAL FOR #2 7STR, Cu, (C/W	HUBBELL BCL018B		
2 48 FIBERS DPGW (REF: R2), C/W HARDWARE FOR TERMINAL 5,000LBS)	PLP 2801309		
SAPACER DAMPER T⊡ BE AD∨ISED BY			С
Γ	NEXT	ra	В
	ENERG	100	_
NEXTERA 5-PACK TRANSMISSION LINE			A
	Engineering Con 3950 Fourteenth Markham, On., Emsil: chimax	npany a Aye. East, Suite 506 L3R 0A9 chimax.ca	A
T 115kV TRANSMISSION LINE LE CONDUCTOR CONFIGURATION AVY ANGLE (60 – 90°) FRAMING			A

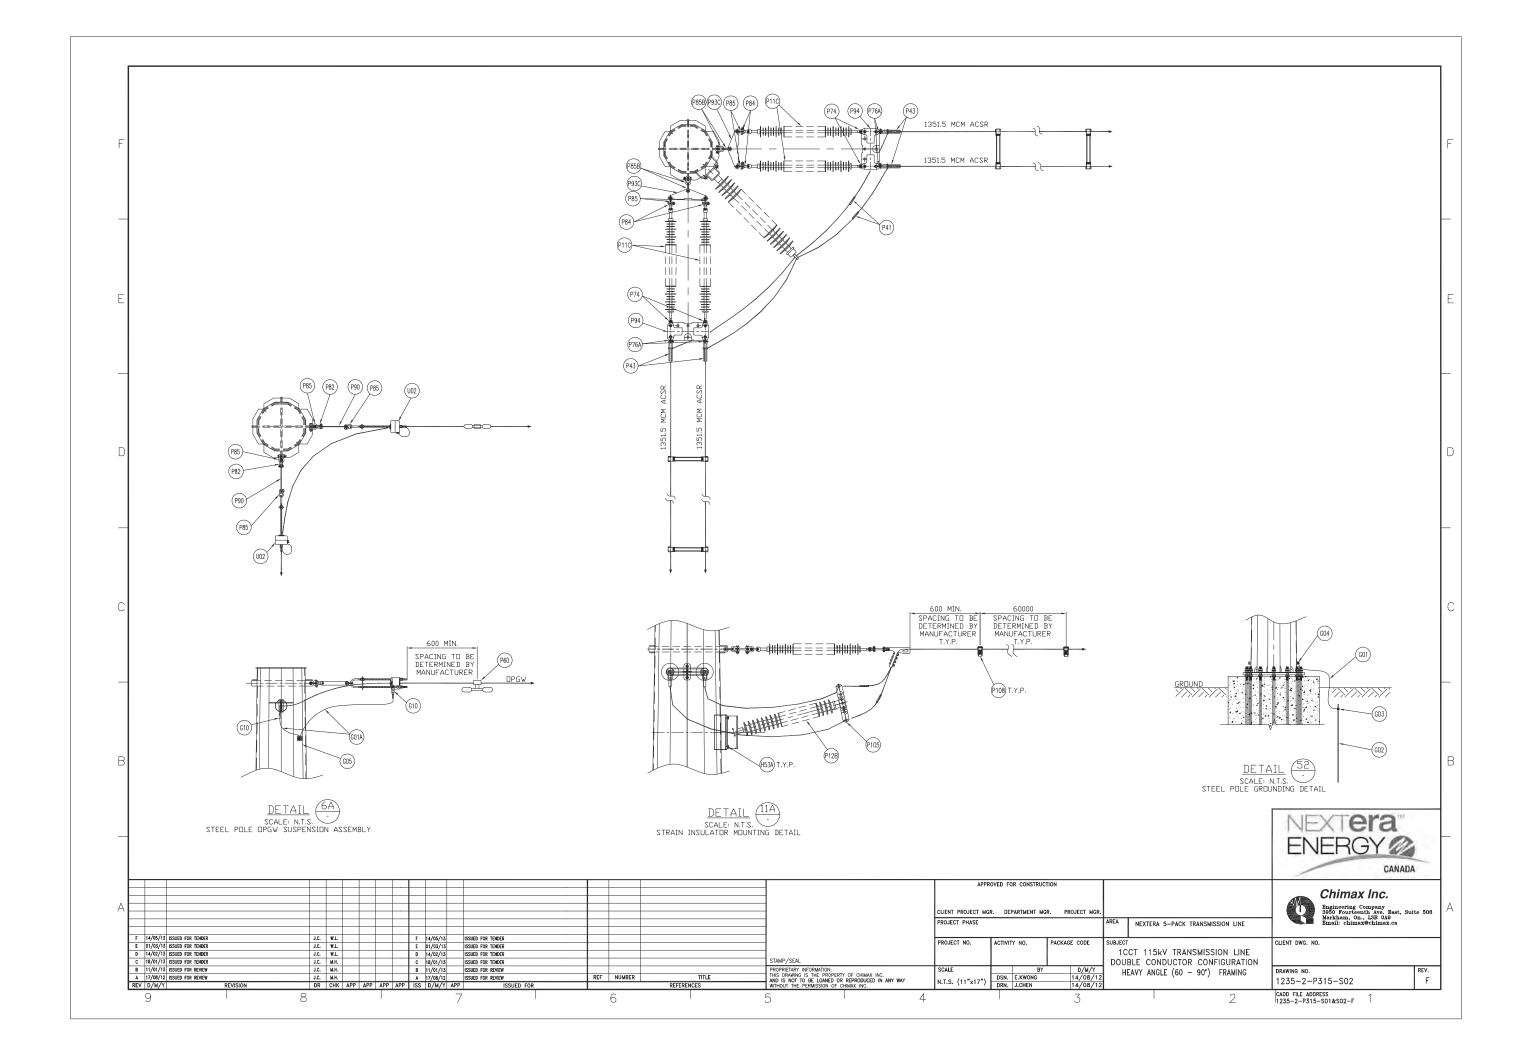

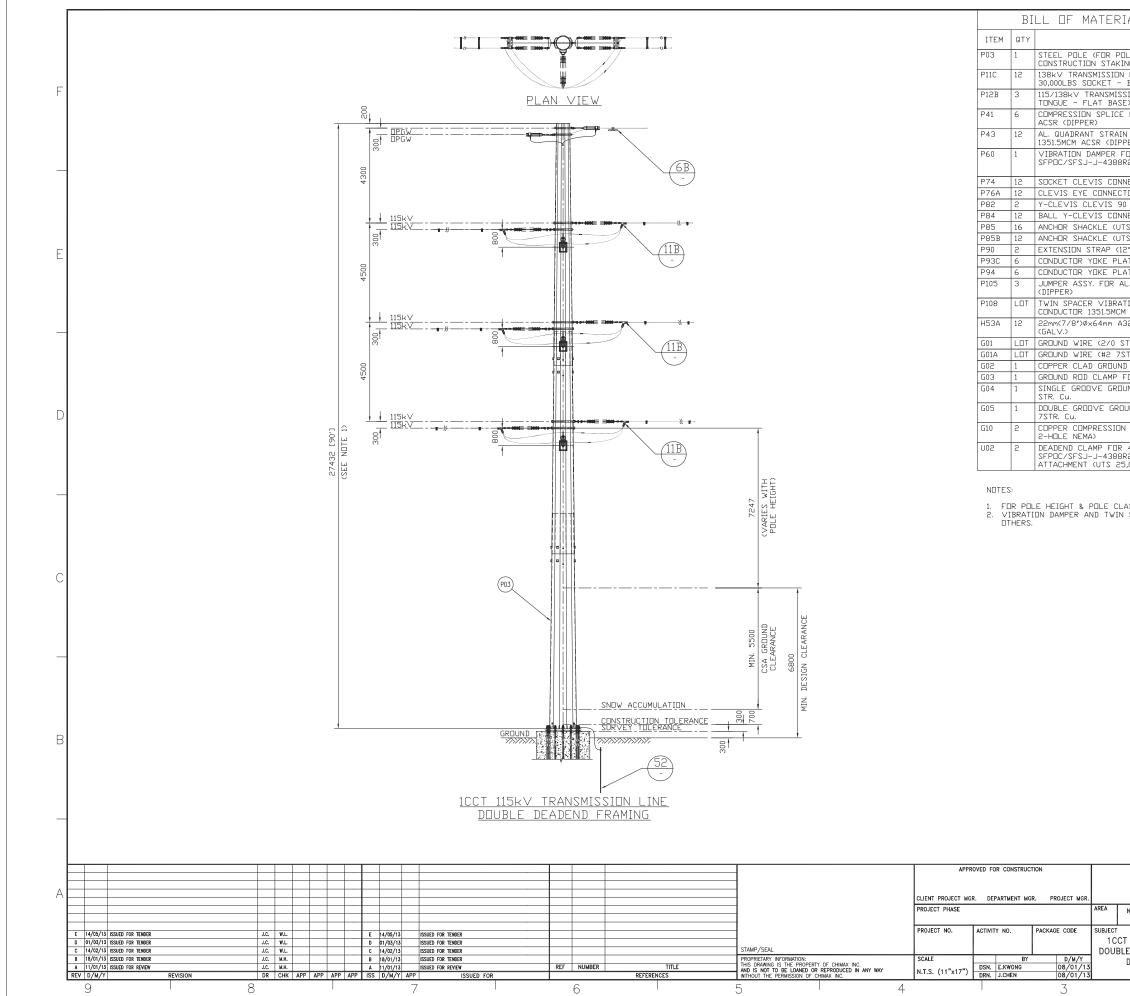



IAL (QUANTITIES SHOW	N FOR 1 ASSEM	(BLY)
DESCRIPTION	MANUFACTURER/NO	REMARKS
JLE LENGTH & CLASS, SEE	OR EQUIVALENT	
ING TABLE)		
I LINE SUSPENSION INSULATOR (SML BALL ENDS)	NGK-LOCKE PART #301-SC390-SJ	
SION LINE POST INSULATOR (DROP	NGK-LOCKE PART #L4-SN321-18	
E> E FOR AL. CONDUCTOR 1351.5MCM	HUBBELL A151561	
N CLAMP FOR AL CONDUCTOR PER) (UTS 35,000LBS)	HUBBELL SD155N	
FOR 48 FIBERS OPGW (REF:		STOCKBRIDGE
R2)		TYPE OR SPIRAL TYPE (T.B.A.)
NECTOR (30,000LBS UTS)	HUBBELL SC301	
TER (UTS 30,000LBS) 0 DEG. CENNECTER (UTS 30,000LBS)	HUBBELL CE054125 HUBBELL YCC3090	
NECTOR (UTS 30,000LBS)	HUBBELL YBC30	
TS 40,000LBS>	HUBBELL AS35BNK	
TS 60,000LBS)	HUBBELL AS50WBNK	
2" LENGTH, UTS 30,000LBS) ATE (UTS 60,000LBS)	HUBBELL ES30781912 HUBBELL YPD60183771	
ATE (UTS 30,000LBS)	HUBBELL YPR30187221	
L. CONDUCTOR 1351.5MCM ACSR	HUBBELL 2717243001	
TION DAMPER FOR TWO AL.	PFISTERER	
M ACSR (DIPPER) (18" SPACING)	182 952-195	
325 BOLT + 2×FLAT WASHER + NUT		
STR. Cu.)		
STR. Cu.)		
D ROD, 3/4" DIA. 10' LENGTH FOR 3/4" DIA. TO 2/0 STR. Cu.	HUBBELL C2030345	T.B.A.
UND CLAMP FOR #4 SOL TO 4/0	HUBBELL GC141AG2	
JUND CLAMP FOR #2 7STR. Cu. & #2	HUBBELL GC143G1 HUBBELL BCL018B	
48 FIBERS DPGW (REF:	PLP 2801309	
R2>, C/W HARDWARE FOR TERMINAL 5,000LBS>		
	NEXT <b>e</b> ENERG	CANADA
NEXTERA 5-PACK TRANSMISSION LINE	Engineering Con 3950 Fourteenth	npany 1 Ave. East, Suite 506
T 115kV TRANSMISSION LINE LE CONDUCTOR CONFIGURATION	CLIENT DWG. NO.	npany a Are. East, Suite 506 LSR 0A9 cchimax.ca REY.
T 115kV TRANSMISSION LINE LE CONDUCTOR CONFIGURATION DOUBLE DEADEND FRAMING		

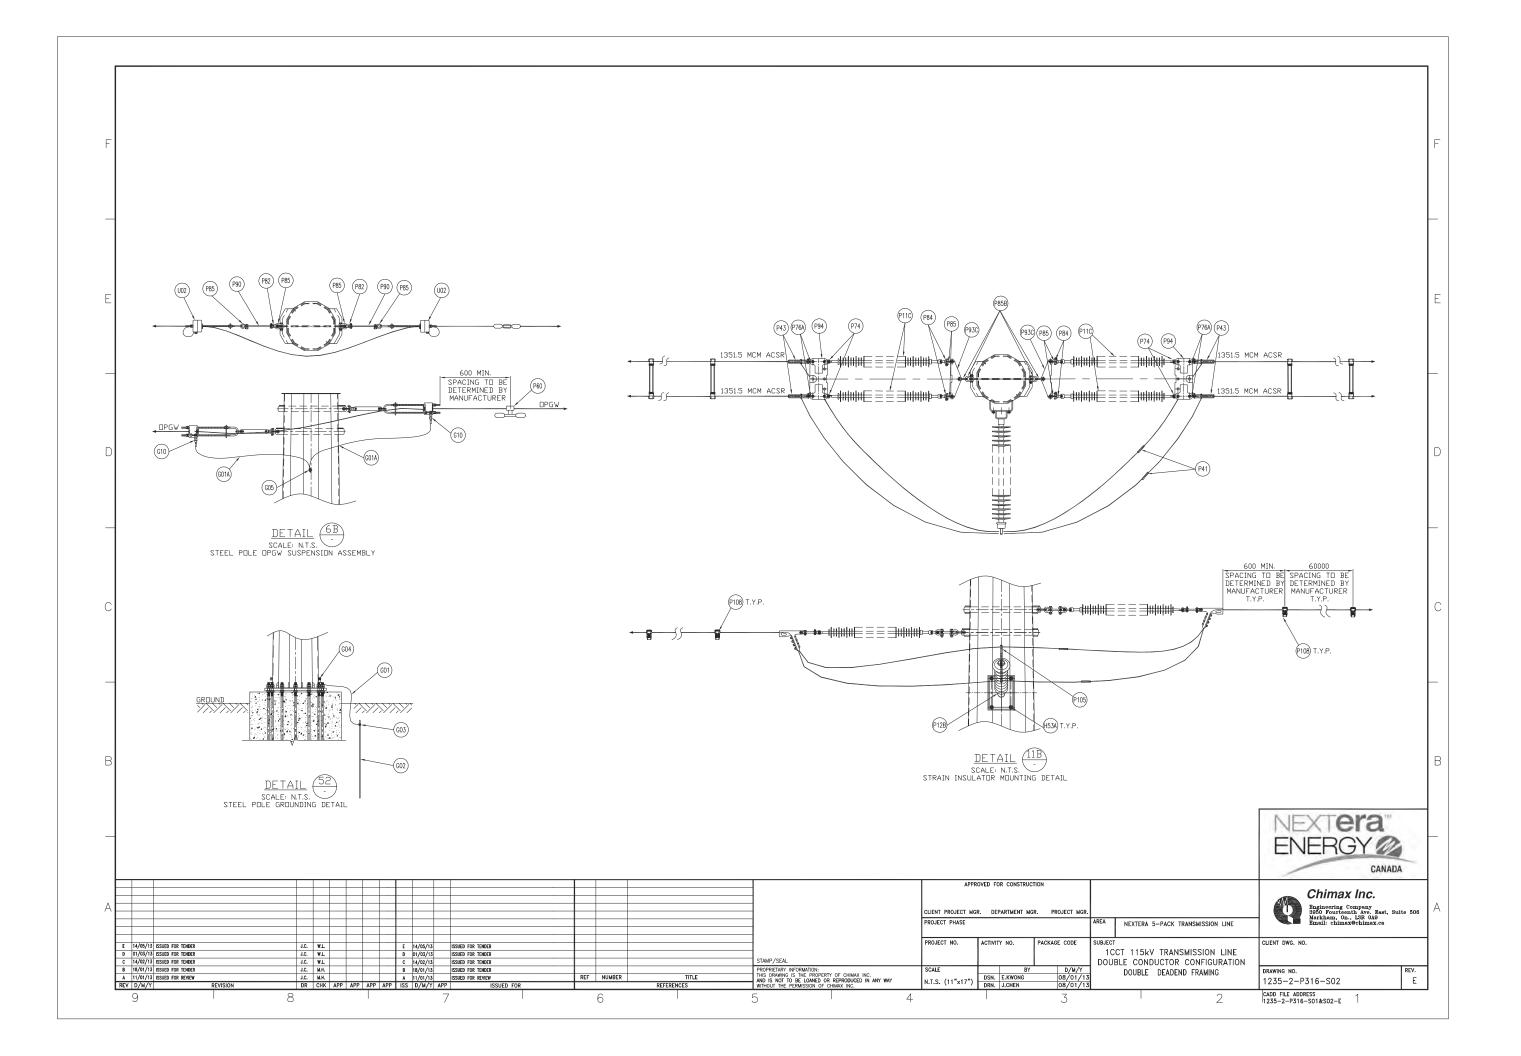

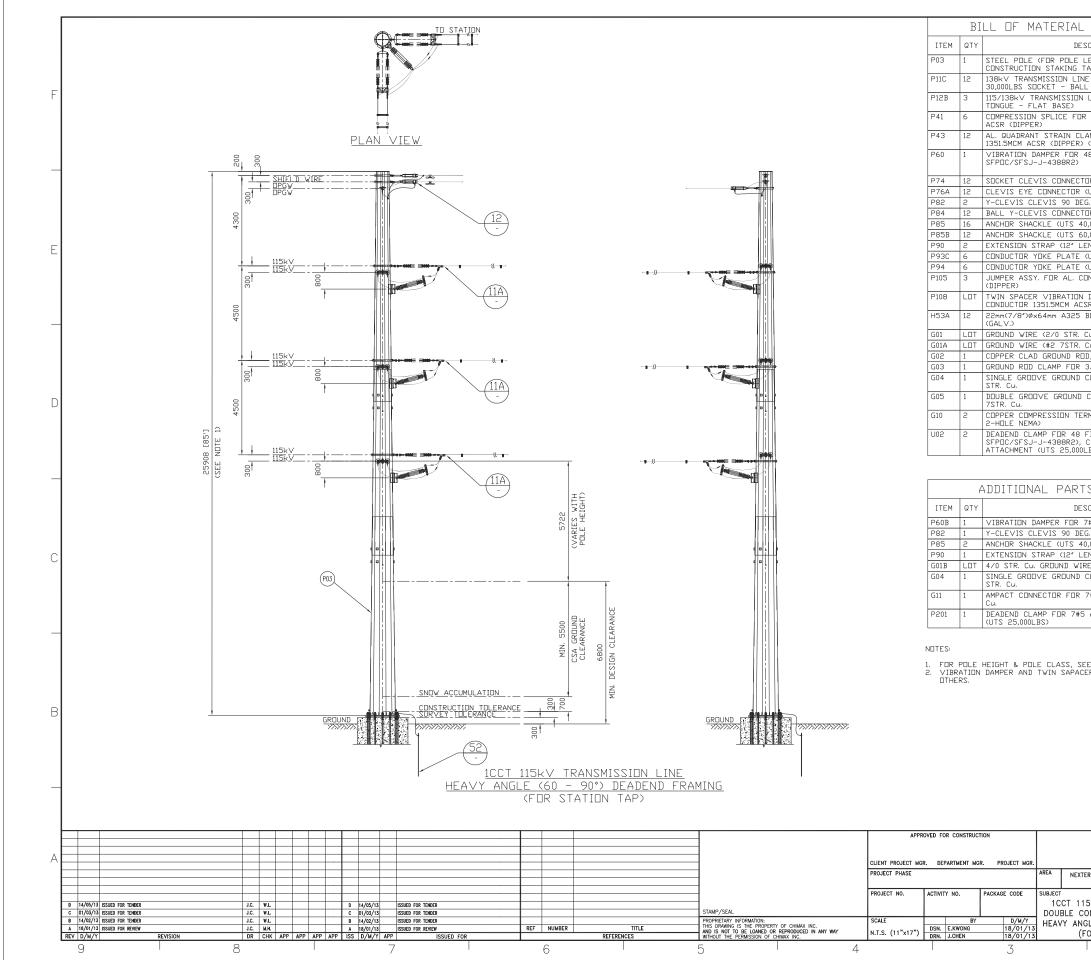


(QUANTITIES SHOWN		
	N FOR 1 ASSEM	IBLY)
SCRIPTION	MANUFACTURER/NO OR EQUIVALENT	REMARKS
LENGTH & CLASS, SEE	UN EQUIVALENT	<u> </u>
TABLE) E SUSPENSION INSULATOR (SML	NGK-LOCKE	
L ENDS)	PART #301-SC390-SJ	
LINE POST INSULATOR (DROP	NGK-LOCKE	
R AL. CONDUCTOR 1351.5MCM	PART #L4-SN321-18 HUBBELL A151561	
AMP FOR AL CONDUCTOR (UTS 35,000LBS)	HUBBELL SD155N	
48 FIBERS DPGW (REF:		STOCKBRIDGE
		TYPE OR SPIRAL TYPE (T.B.A.)
DR (30,000LBS UTS)	HUBBELL SC301	
(UTS 30,000LBS)	HUBBELL CE054125	
G. CONNECTOR (UTS 30,000LBS)	HUBBELL YCC3090	
DR (UTS 30,000LBS) 0,000LBS)	HUBBELL YBC30 HUBBELL AS35BNK	
D,000LBS)	HUBBELL AS50WBNK	
ENGTH, UTS 30,000LBS>	HUBBELL ES30781912	
(UTS 60,000LBS)	HUBBELL YPD60183771	
(UTS 30,000LBS) DNDUCTUR 1351.5MCM ACSR	HUBBELL YPR30187221 HUBBELL 2717243001	
DAMPER FOR TWO AL. SR (DIPPER) (18" SPACING)	PFISTERER 182 952-195	
BOLT + 2×FLAT WASHER + NUT	100 700-170	
Cu.)		
Cu.) D, 3/4″ DIA. 10′ LENGTH		T.B.A.
3/4" DIA. TO 2/0 STR. Cu.	HUBBELL C2030345	יחימיי
CLAMP FOR #4 SOL TO 4/0	HUBBELL GC141AG2	
CLAMP FUD #2 75TD C+ 0 #2	HURRELL COLADO	
CLAMP FOR #2 7STR. Cu. & #2	HUBBELL GC143G1	
RMINAL FOR #2 7STR. Cu. (C/W	HUBBELL BCL018B	
FIBERS OPGW (REF:	PLP 2801309	<u> </u>
C/W HARDWARE FOR TERMINAL	. 2. 2001007	
LR21		
	TAD TO \$7.4	
S FOR SHIELD WIRE		
SCRIPTION	MANUFACTURER/NO OR EQUIVALENT	REMARKS
7#5 ALUMOWELD SHIELD WIRE	HUBBELL 607051011	
G. CONNECTOR (UTS 30,000LBS)	HUBBELL YCC3090	
D,000LBS)	HUBBELL AS35BNK	
EDUCTION AND AND AND AND AND AND AND AND AND AN	HUBBELL ES30781912	
RE	HUBBELL GC141AG2	
RE Clamp for #4 Sol to 4/0		
RE Clamp for #4 Sol to 4/0	HUBBELL GC141AG2 AMP 600466	
RE CLAMP FOR #4 SOL TO 4/0 7#5 ALUMOWELD TO 4/0 STR.		
RE CLAMP FOR #4 SOL TO 4/0 7#5 ALUMOWELD TO 4/0 STR.	AMP 600466	
RE CLAMP FOR #4 SOL TO 4/0 7#5 ALUMOWELD TO 4/0 STR.	AMP 600466	
RE CLAMP FOR #4 SOL TO 4/0 7#5 ALUMOWELD TO 4/0 STR. ALUMOWELD SHIELD WIRE EE CONSTRUCTION STAKING TABLE	AMP 600466 PLP VG-18-3000	
RE CLAMP FOR #4 SOL TO 4/0 7#5 ALUMOWELD TO 4/0 STR. ALUMOWELD SHIELD WIRE EE CONSTRUCTION STAKING TABLE	AMP 600466 PLP VG-18-3000	
RE CLAMP FOR #4 SOL TO 4/0 7#5 ALUMOWELD TO 4/0 STR. ALUMOWELD SHIELD WIRE EE CONSTRUCTION STAKING TABLE	AMP 600466 PLP VG-18-3000	
RE CLAMP FOR #4 SOL TO 4/0 7#5 ALUMOWELD TO 4/0 STR. ALUMOWELD SHIELD WIRE EE CONSTRUCTION STAKING TABLE	AMP 600466 PLP VG-18-3000	
RE CLAMP FOR #4 SOL TO 4/0 7#5 ALUMOWELD TO 4/0 STR. ALUMOWELD SHIELD WIRE EE CONSTRUCTION STAKING TABLE	AMP 600466 PLP VG-18-3000	
RE CLAMP FOR #4 SOL TO 4/0 7#5 ALUMOWELD TO 4/0 STR. ALUMOWELD SHIELD WIRE EE CONSTRUCTION STAKING TABLE	AMP 600466 PLP VG-18-3000	
RE CLAMP FOR #4 SOL TO 4/0 7#5 ALUMOWELD TO 4/0 STR. ALUMOWELD SHIELD WIRE EE CONSTRUCTION STAKING TABLE	AMP 600466 PLP VG-18-3000	
RE CLAMP FOR #4 SOL TO 4/0 7#5 ALUMOWELD TO 4/0 STR. ALUMOWELD SHIELD WIRE EE CONSTRUCTION STAKING TABLE	AMP 600466 PLP VG-18-3000	
RE CLAMP FOR #4 SOL TO 4/0 7#5 ALUMOWELD TO 4/0 STR. ALUMOWELD SHIELD WIRE EE CONSTRUCTION STAKING TABLE	AMP 600466 PLP VG-18-3000	ra
RE CLAMP FOR #4 SOL TO 4/0 7#5 ALUMOWELD TO 4/0 STR. ALUMOWELD SHIELD WIRE EE CONSTRUCTION STAKING TABLE	AMP 600466 PLP VG-18-3000	ra
RE CLAMP FOR #4 SOL TO 4/0 7#5 ALUMOWELD TO 4/0 STR. ALUMOWELD SHIELD WIRE EE CONSTRUCTION STAKING TABLE	AMP 600466 PLP VG-18-3000	ra
RE CLAMP FOR #4 SOL TO 4/0 7#5 ALUMOWELD TO 4/0 STR. ALUMOWELD SHIELD WIRE EE CONSTRUCTION STAKING TABLE	AMP 600466 PLP VG-18-3000	
RE CLAMP FOR #4 SOL TO 4/0 7#5 ALUMOWELD TO 4/0 STR. ALUMOWELD SHIELD WIRE EE CONSTRUCTION STAKING TABLE	AMP 600466 PLP VG-18-3000	
RE CLAMP FOR #4 SOL TO 4/0 7#5 ALUMOWELD TO 4/0 STR. ALUMOWELD SHIELD WIRE EE CONSTRUCTION STAKING TABLE	AMP 600466 PLP VG-18-3000 E.	
RE CLAMP FOR #4 SOL TO 4/0 7#5 ALUMOWELD TO 4/0 STR. ALUMOWELD SHIELD WIRE EE CONSTRUCTION STAKING TABLE	AMP 600466 PLP VG-18-3000 E. NEXTE ENERG Chimax	Inc.
RE CLAMP FOR #4 SOL TO 4/0 7#5 ALUMOWELD TO 4/0 STR. ALUMOWELD SHIELD WIRE ECONSTRUCTION STAKING TABLE ER DAMPER TO BE ADVISED BY	AMP 600466 PLP VG-18-3000 E. NEXTE ENERG Chimax	Inc.
RE CLAMP FOR #4 SOL TO 4/0 7#5 ALUMOWELD TO 4/0 STR. ALUMOWELD SHIELD WIRE EE CONSTRUCTION STAKING TABLE ER DAMPER TO BE ADVISED BY	AMP 600466 PLP VG-18-3000 E. NEXTE ENERG Chimax	
RE CLAMP FOR #4 SOL TO 4/0 7#5 ALUMOWELD TO 4/0 STR. 7 ALUMOWELD SHIELD WIRE EE CONSTRUCTION STAKING TABLE ER DAMPER TO BE ADVISED BY ER DAMPER TO BE ADVISED BY	AMP 600466 PLP VG-18-3000 E. NEXTE ENERG Chimax	Inc.
RE CLAMP FOR #4 SOL TO 4/0 7#5 ALUMOWELD TO 4/0 STR. ALUMOWELD SHIELD WIRE CE CONSTRUCTION STAKING TABLE ER DAMPER TO BE ADVISED BY ER 5-PACK TRANSMISSION LINE 5kV TRANSMISSION LINE	AMP 600466 PLP VG-18-3000 E. E. E. E. E. E. E. E. E. E.	Inc.
RE CLAMP FOR #4 SOL TO 4/0 7#5 ALUMOWELD TO 4/0 STR. ALUMOWELD SHIELD WIRE EE CONSTRUCTION STAKING TABLE ER DAMPER TO BE ADVISED BY ERA 5-PACK TRANSMISSION LINE 5KV TRANSMISSION LINE ONDUCTOR CONFIGURATION	AMP 600466 PLP VG-18-3000 E. E. E. E. E. E. E. E. E. E.	Inc.
ERA 5-PACK TRANSMISSION LINE 5kV TRANSMISSION LINE GL (60 - 90*) FRAMING	AMP 600466 PLP VG-18-3000 E. E. E. E. E. E. E. E. E. E.	Inc. Jagany Jare, Rast, Suite 508 Jar 049 chimax.ca

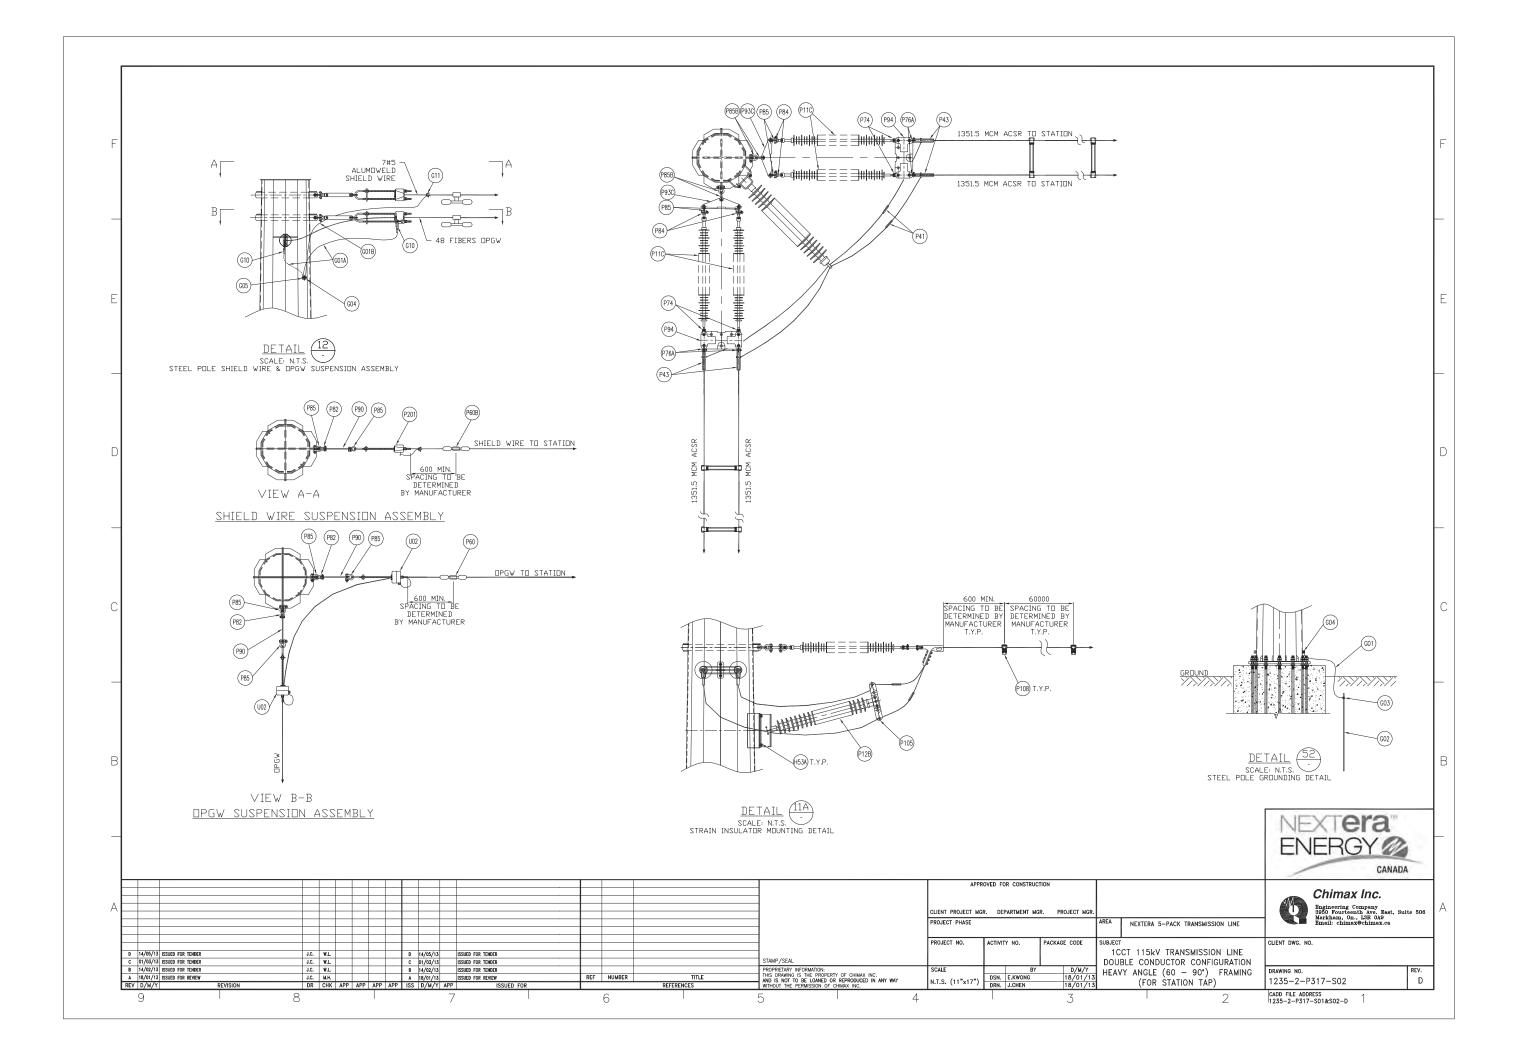


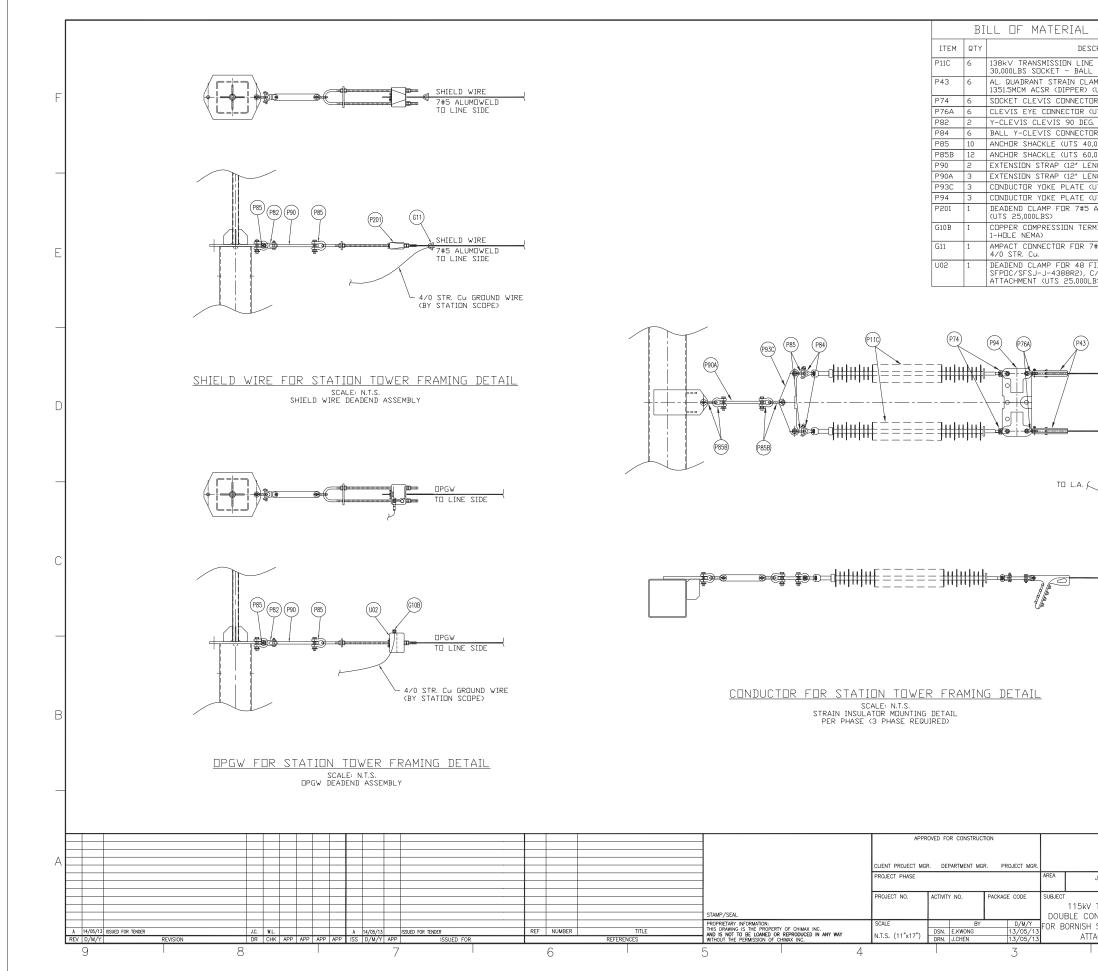



_ (QUANTITIES SHOW)	N FOR 1 ASSEMBLY)	
ESCRIPTION	MANUFACTURER/NO REMARKS	
NE SUSPENSION INSULATOR (SML	OR EQUIVALENT	
LL ENDS)	PART #301-SC390-SJ	
LAMP FOR AL CONDUCTOR > (UTS 35,000LBS)	HUBBELL SD155N	
TDR (30,000LBS UTS)	HUBBELL SC301	F
CUTS 30,000LBS) EG. CONNECTOR (UTS 30,000LBS)	HUBBELL CE054125 HUBBELL YCC3090	
TOR (UTS 30,000LBS)	HUBBELL YBC30	
40,000LBS> 60,000LBS>	HUBBELL AS35BNK HUBBELL AS50WBNK	
LENGTH, UTS 30,000LBS)	HUBBELL ES30781912	
LENGTH, UTS 60,000LBS>	HUBBELL ES60781912	-
(UTS 60,000LBS) (UTS 30,000LBS)	HUBBELL YPD60183771 HUBBELL YPR30187221	
5 ALUMOWELD SHIELD WIRE	PLP VG-18-3000	
ERMINAL FOR 4/0 STR. Cu. (C/W		
ERMINAL FOR 470 STR. CU. (C/W	HUBBELL VHCL4012	
7#5 ALUMOWELD TO	AMP 600466	E
FIBERS DPGW (REF:	PLP 2801309	
, C/W HARDWARE FOR TERMINAL		
<		$\vdash$
3)		
	1351.5MCM ACSR WIRE	
		D
	1351.5MCM ACSR WIRE	
6		$\vdash$
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	NEXTERA	
		L
	ENERGY 22	
	CANADA	
	CANADA	
	👝 Chimax Inc.	
		A
	Engineering Company 3950 Fourteenth Ave. East, Suite 506 Markham, On., L3R 0.49 Email: chimax@chimax.ca	$ ^{-}$
JERICHO WIND PROJECT	small: chimax@chimax.ca	
	LIENT DWG. NO.	1
V TRANSMISSION LINE CONDUCTOR CONFIGURATION		
SH STATION & JERICHO STATION	RAWING NO. REV.	1
TTACHMENT DETAILS	1235–3–P133 A	
2	CADD FILE ADDRESS 1 235-3-P133-A 1	

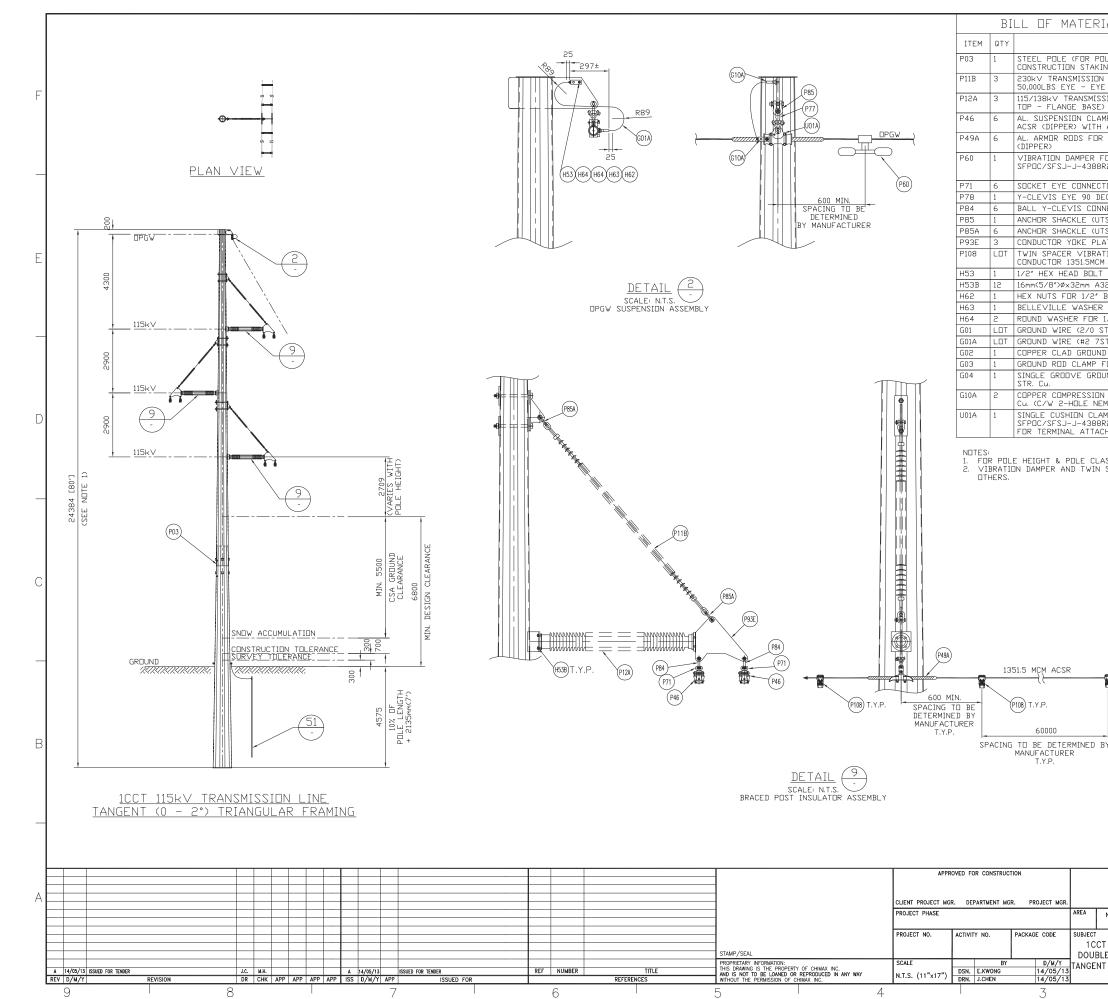



IAL (QUANTITIES SHOW	N FOR 1 ASSEN	(RLY)
	MANUFACTURER/NO	
DESCRIPTION DLE LENGTH & CLASS, SEE	OR EQUIVALENT	REMARKS
ING TABLE)		
N LINE SUSPENSION INSULATOR (SML E ENDS)	NGK-LOCKE PART #502-SC690-EE	
SION LINE POST INSULATOR (FLANGE	NGK-LOCKE	
) MP FOR AL. CONDUCTOR 1351.5MCM	PART #L4-SN321-55U HUBBELL HAS252N	
ARMOR RODS (UTS 30,000LBS)		
R AL. CONDUCTOR 1351.5MCM ACSR	PLP AR-0146	
FOR 48 FIBERS OPGW (REF: R2)		STOCKBRIDGE TYPE OR SPIRAL
		TYPE (T.B.A.)
TOR (30,000LBS UTS) EG. CONNECTOR (UTS 25,000LBS)	HUBBELL SA22 HUBBELL YCS0690	
NECTOR (UTS 30,000LBS)	HUBBELL YBC30	
TS 40,000LBS)	HUBBELL AS35BNK	
TS 60,000LBS) ATE FOR BRACED POST INSULATOR	HUBBELL AS50BNK	DWG#: 1235-2-F017
TION DAMPER FOR TWO AL.	PFISTERER	Dwd#: 1233-2-F017
ACSR (DIPPER) (18" SPACING)	182 952-195	
I (STAINLESS STEEL) 325 BOLT + 2×FLAT WASHER (GALV.	HUBBELL HBS150	
BOLTS (STAINLESS STEEL)	HUBBELL HNS500	
R FOR 1/2" BOLT (STAINLESS STEEL		
1/2" BOLT (STAINLESS STEEL) STR, Cu.)	HUBBELL HFS500	
STR. Cu.)		
D ROD, 3/4″ DIA. 10′ LENGTH		T.B.A.
FOR 3/4" DIA. TO 2/0 STR. Cu.	HUBBELL C2030345	
UND CLAMP FOR #4 SOL TO 4/0	HUBBELL GC141AG2	
N TERMINAL 90 DEG, FOR #2 7STR. MA)	HUBBELL BCL018BY90	
MP FOR 48 FIBERS OPGW (REF:	PLP 4700105	
R2), C/W ARMOR ROD AND HARDWARE CHMENT (UTS 20,000LBS)	=	
GREUND		
~~~~~~~		(603)
		<. (63) (62)
BY D SCA	ETAIL 51 GROUNDING DETAIL	$\bigcirc$
BY D SCA	\ _ /	$\bigcirc$
BY D SCA	ALE: N.T.S. GROUNDING DETAIL	
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D SCA BY D STEEL POLE T 115kV TRANSMISSION LINE LE CONDUCTOR CONFIGURATION T (0 - 2*) TRIANGULAR FRAMING	ALE: N.T.S. GROUNDING DETAIL	

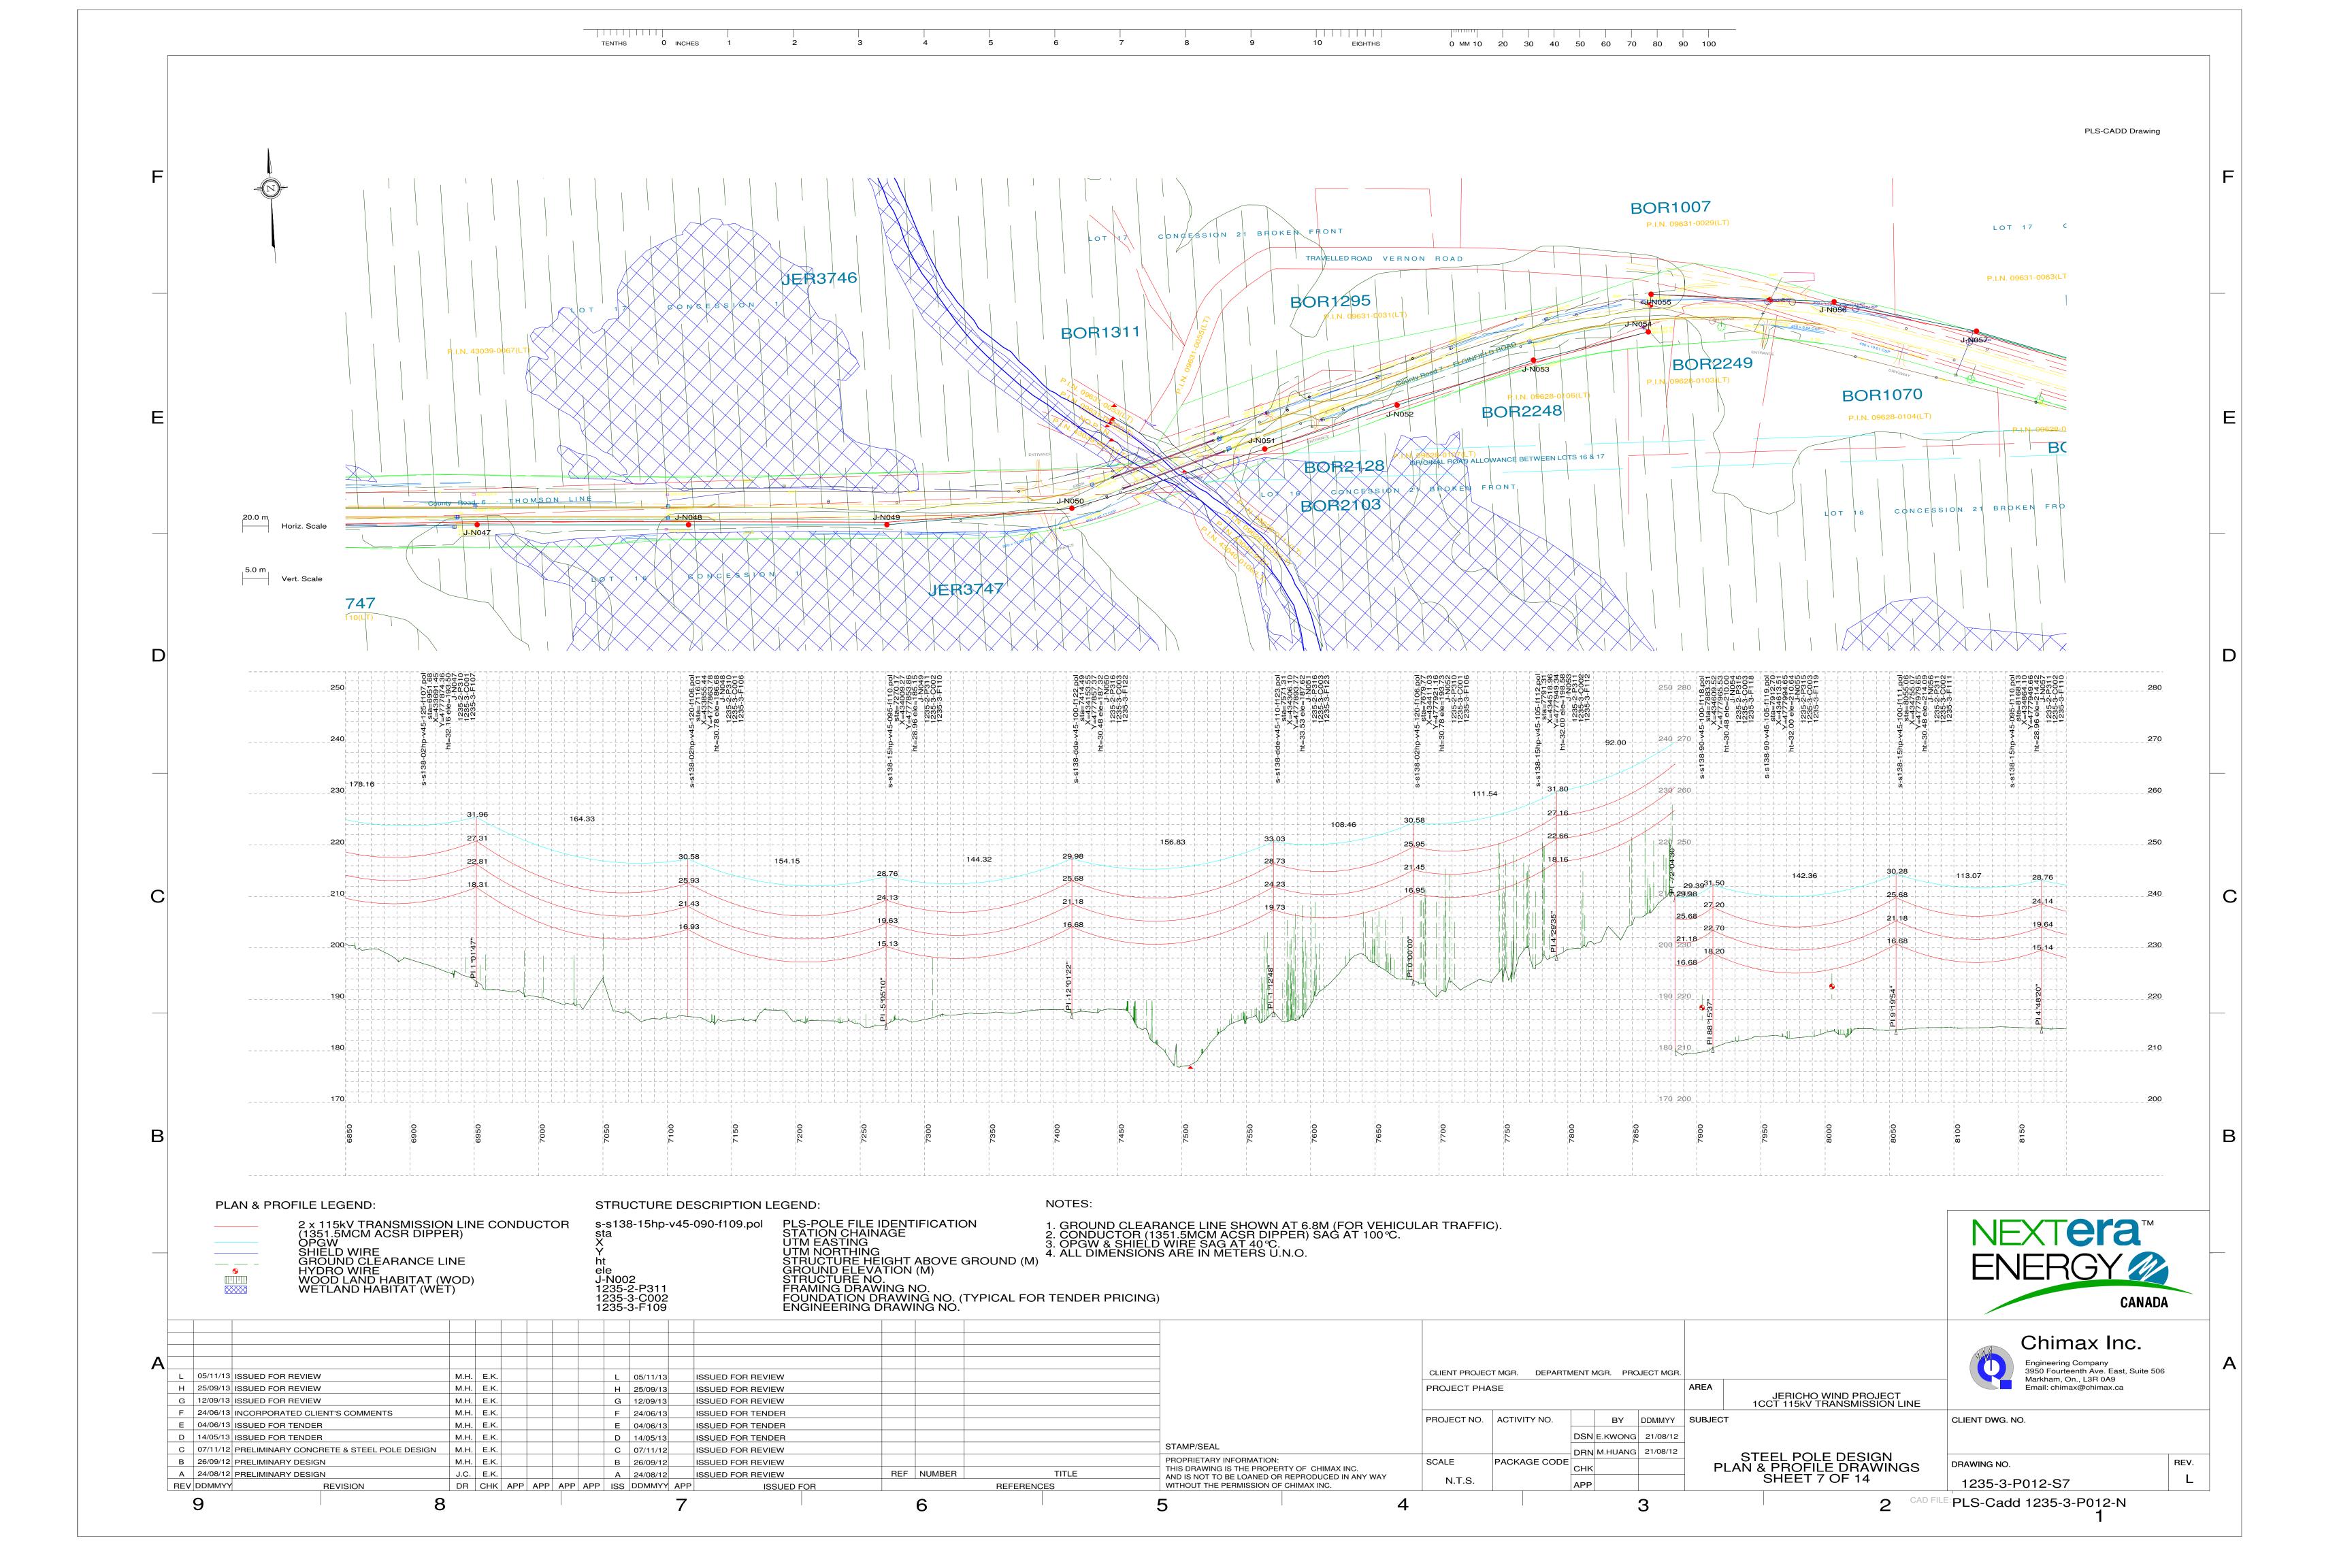


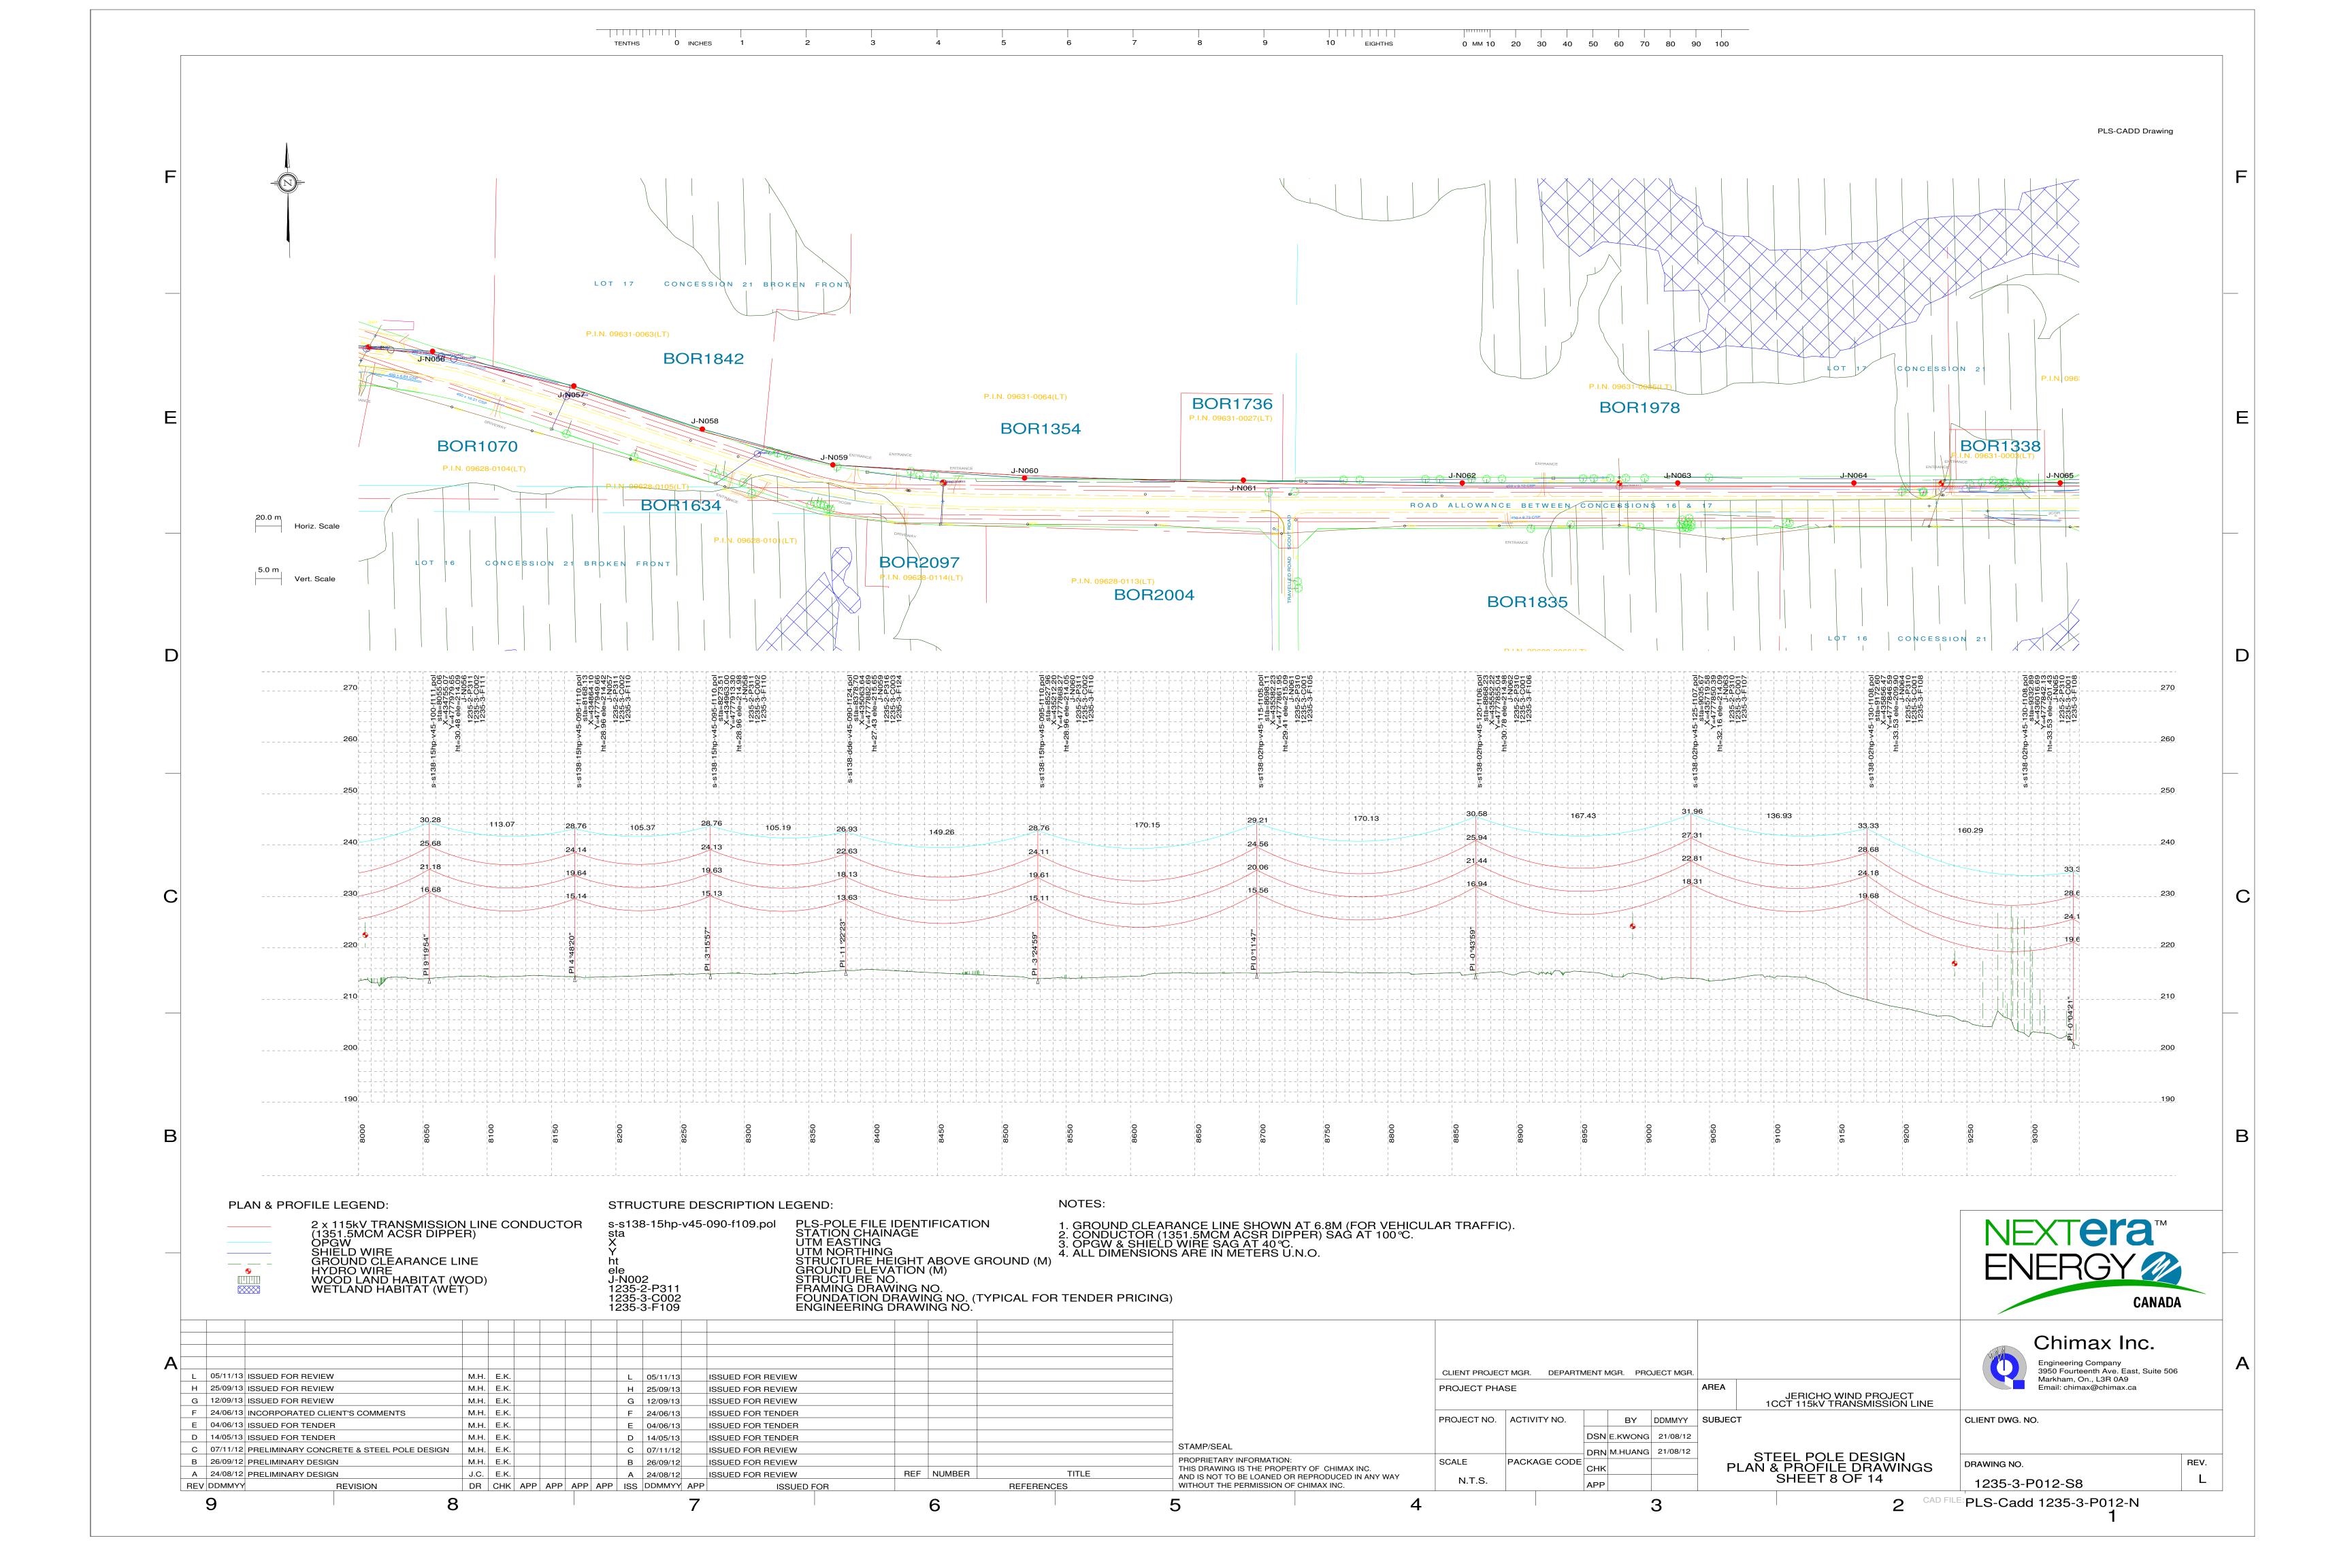


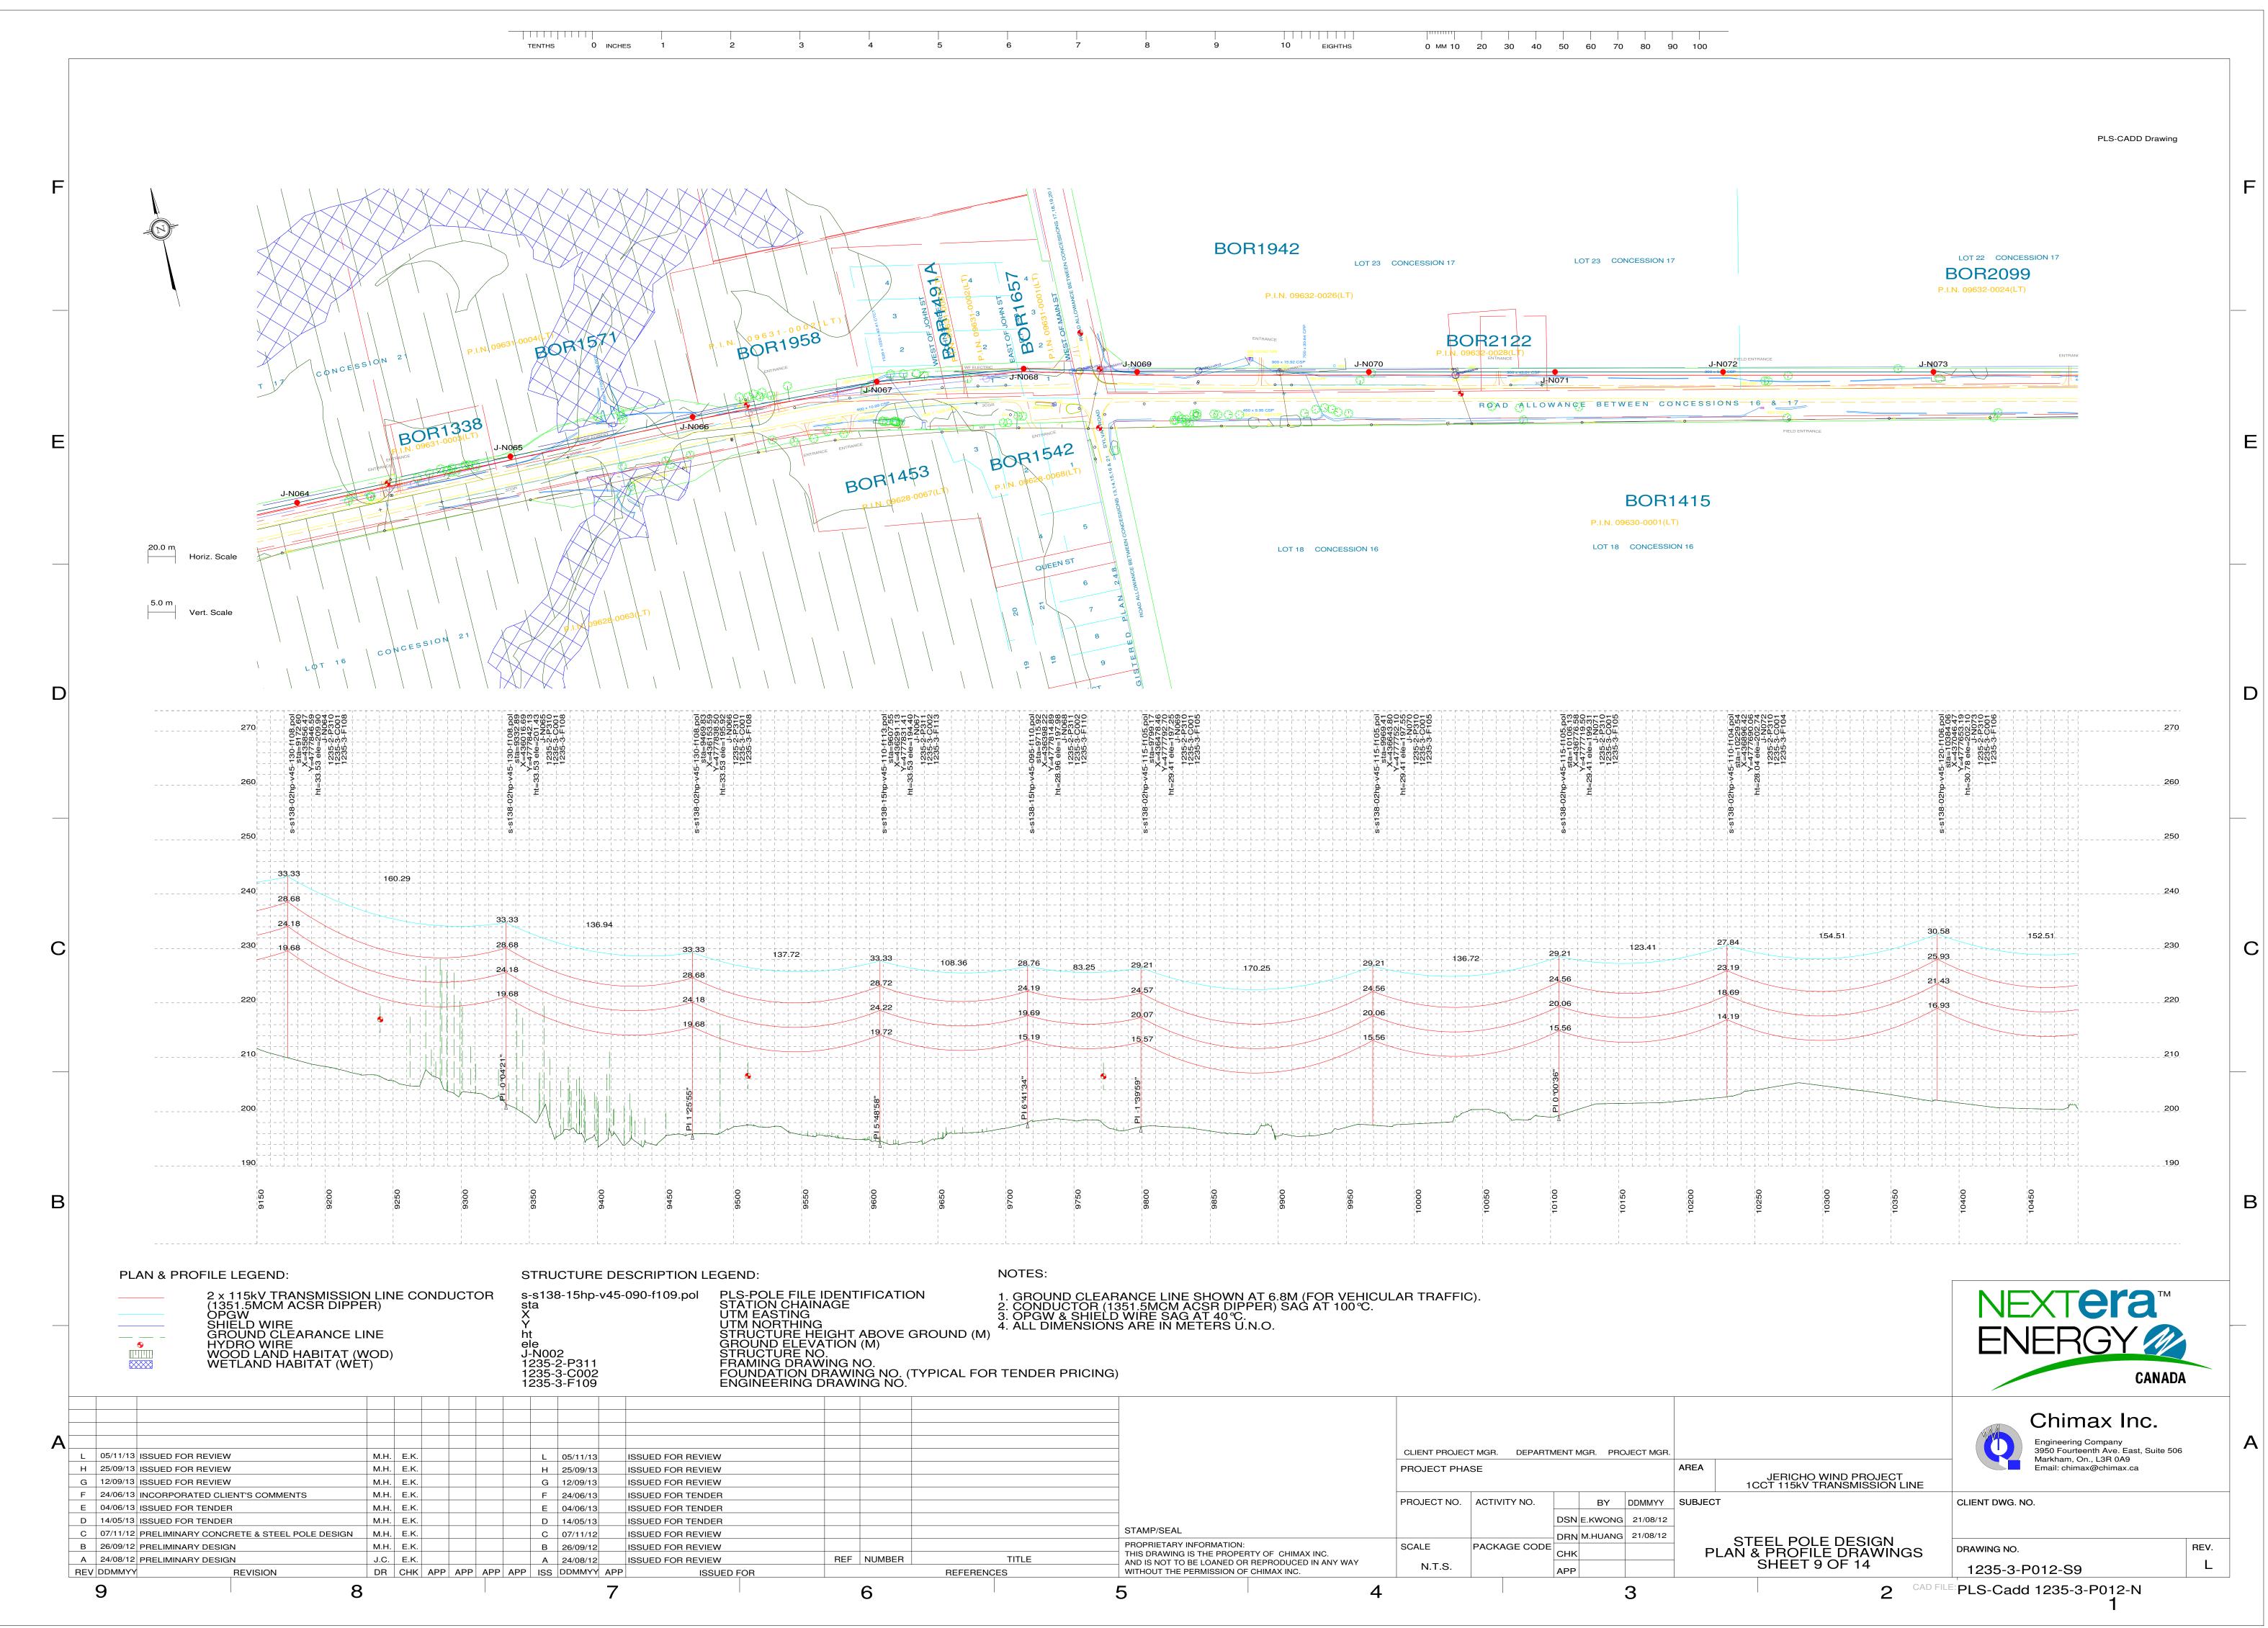


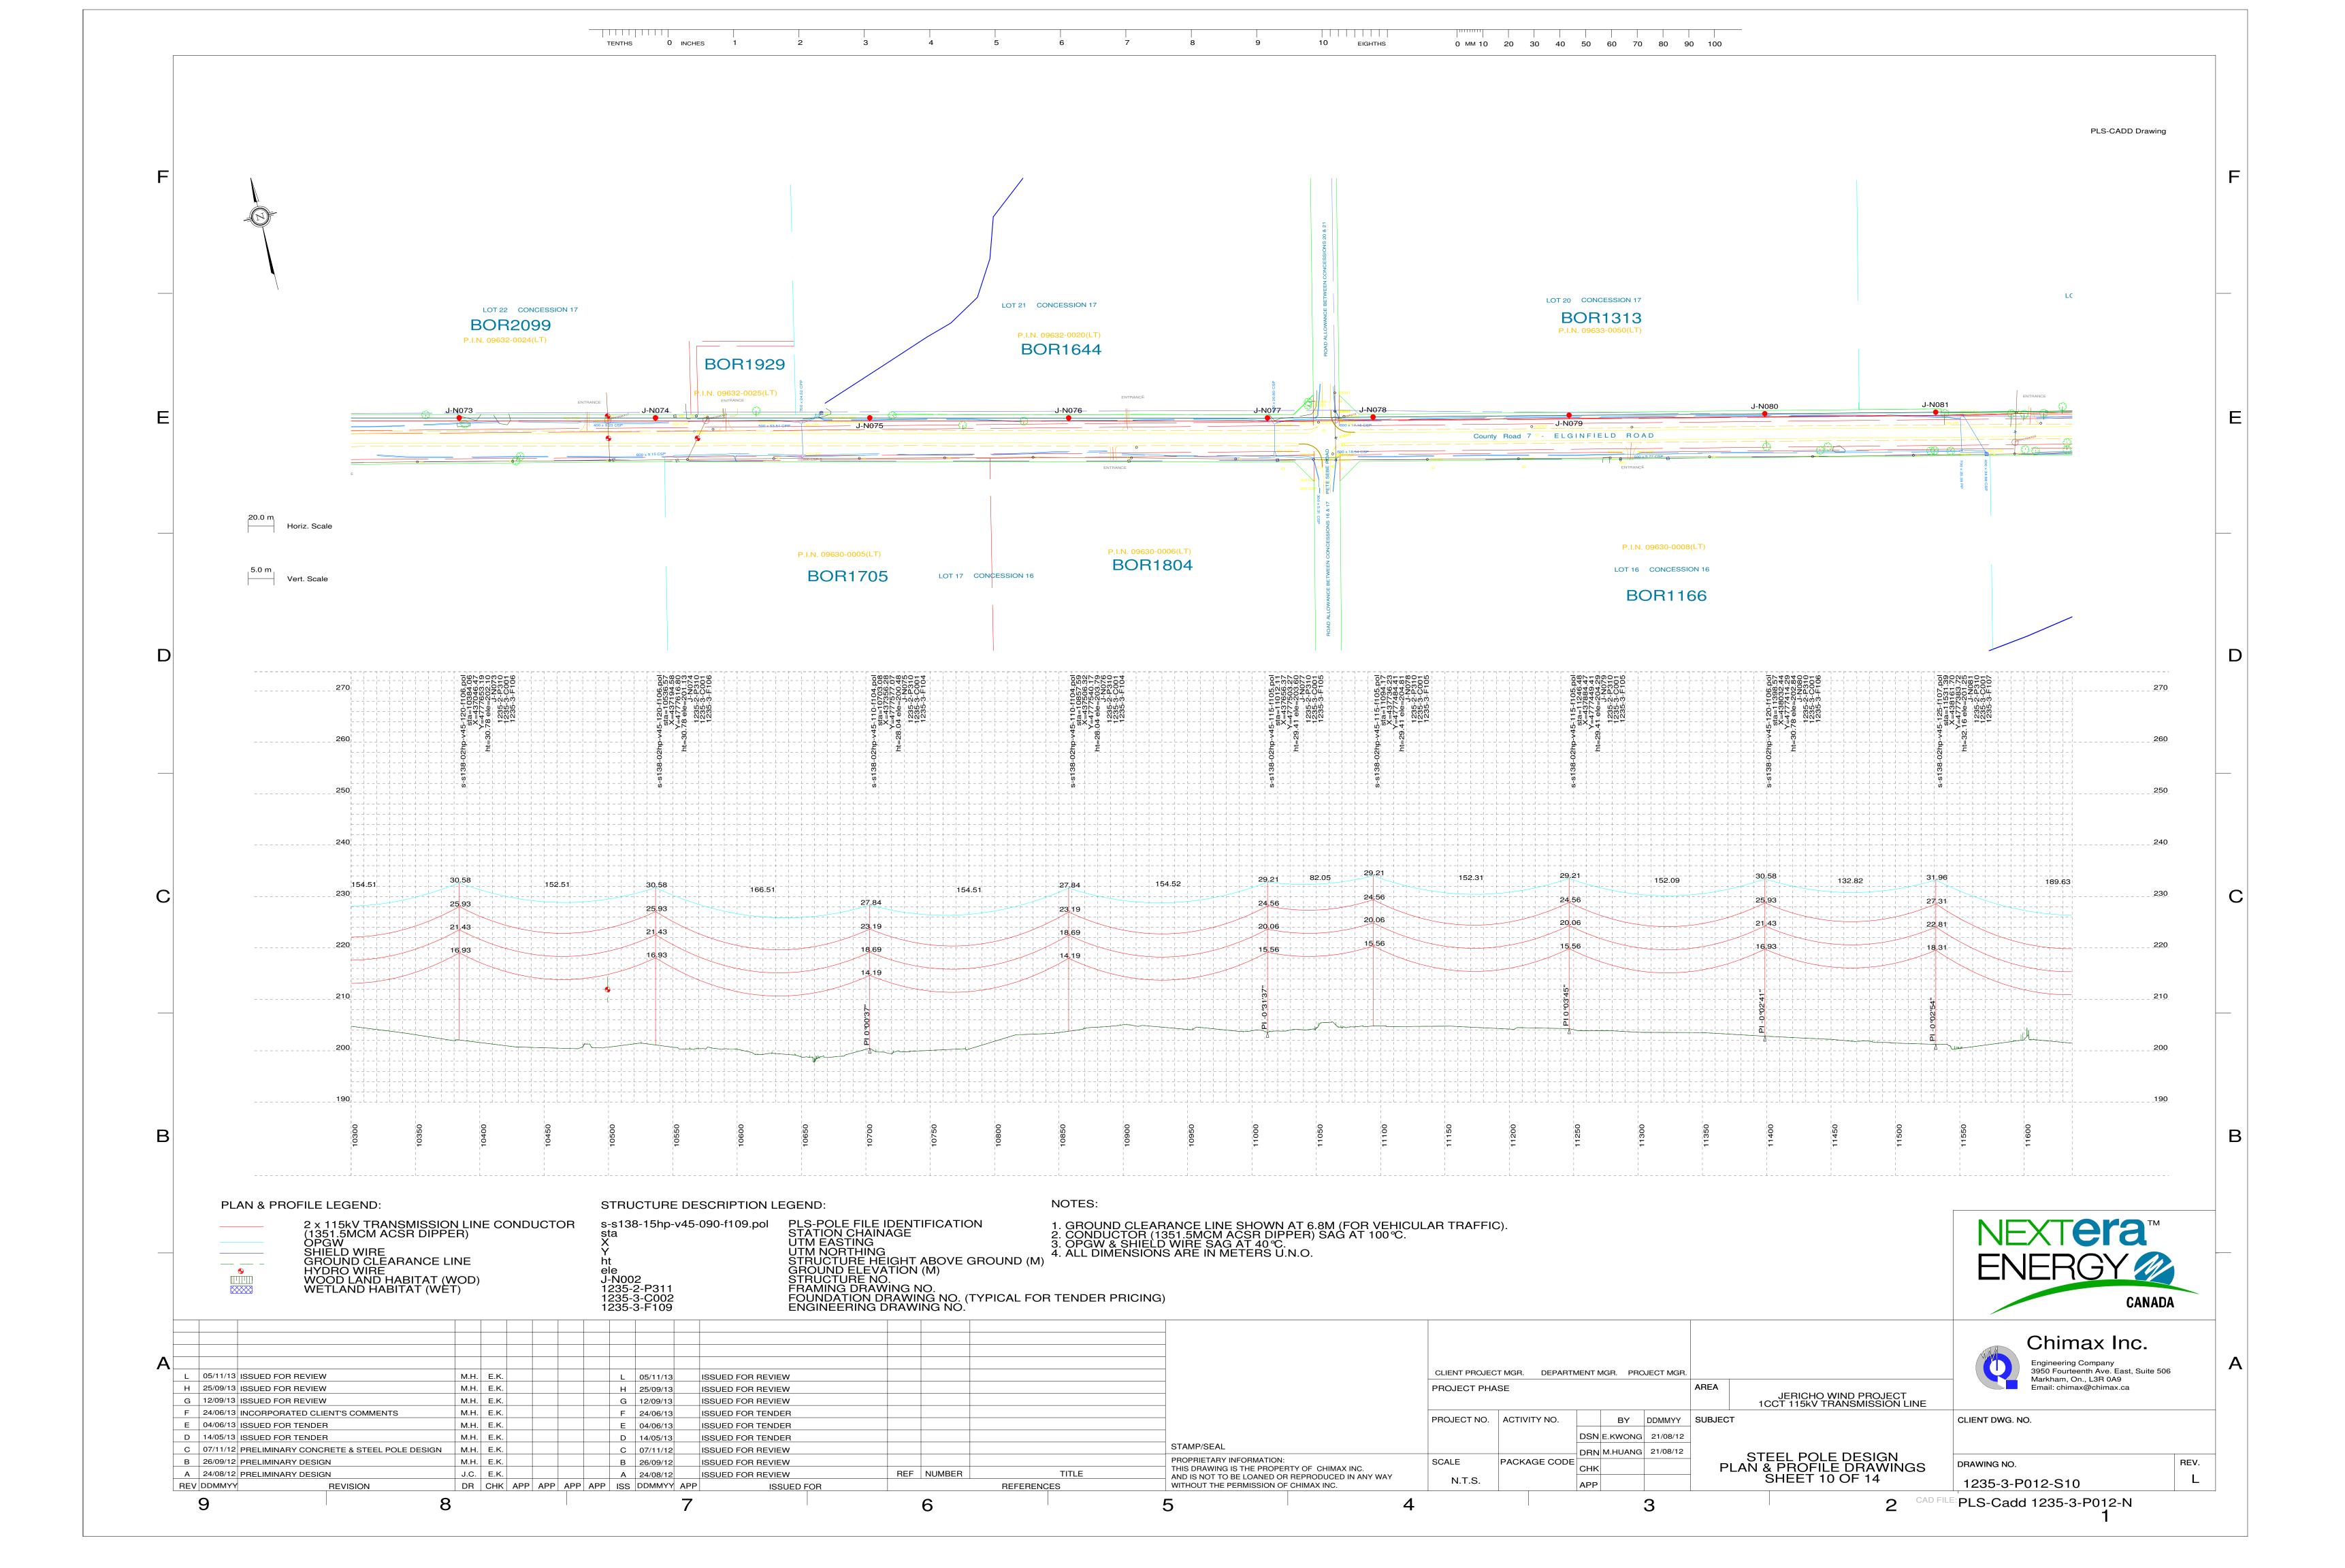

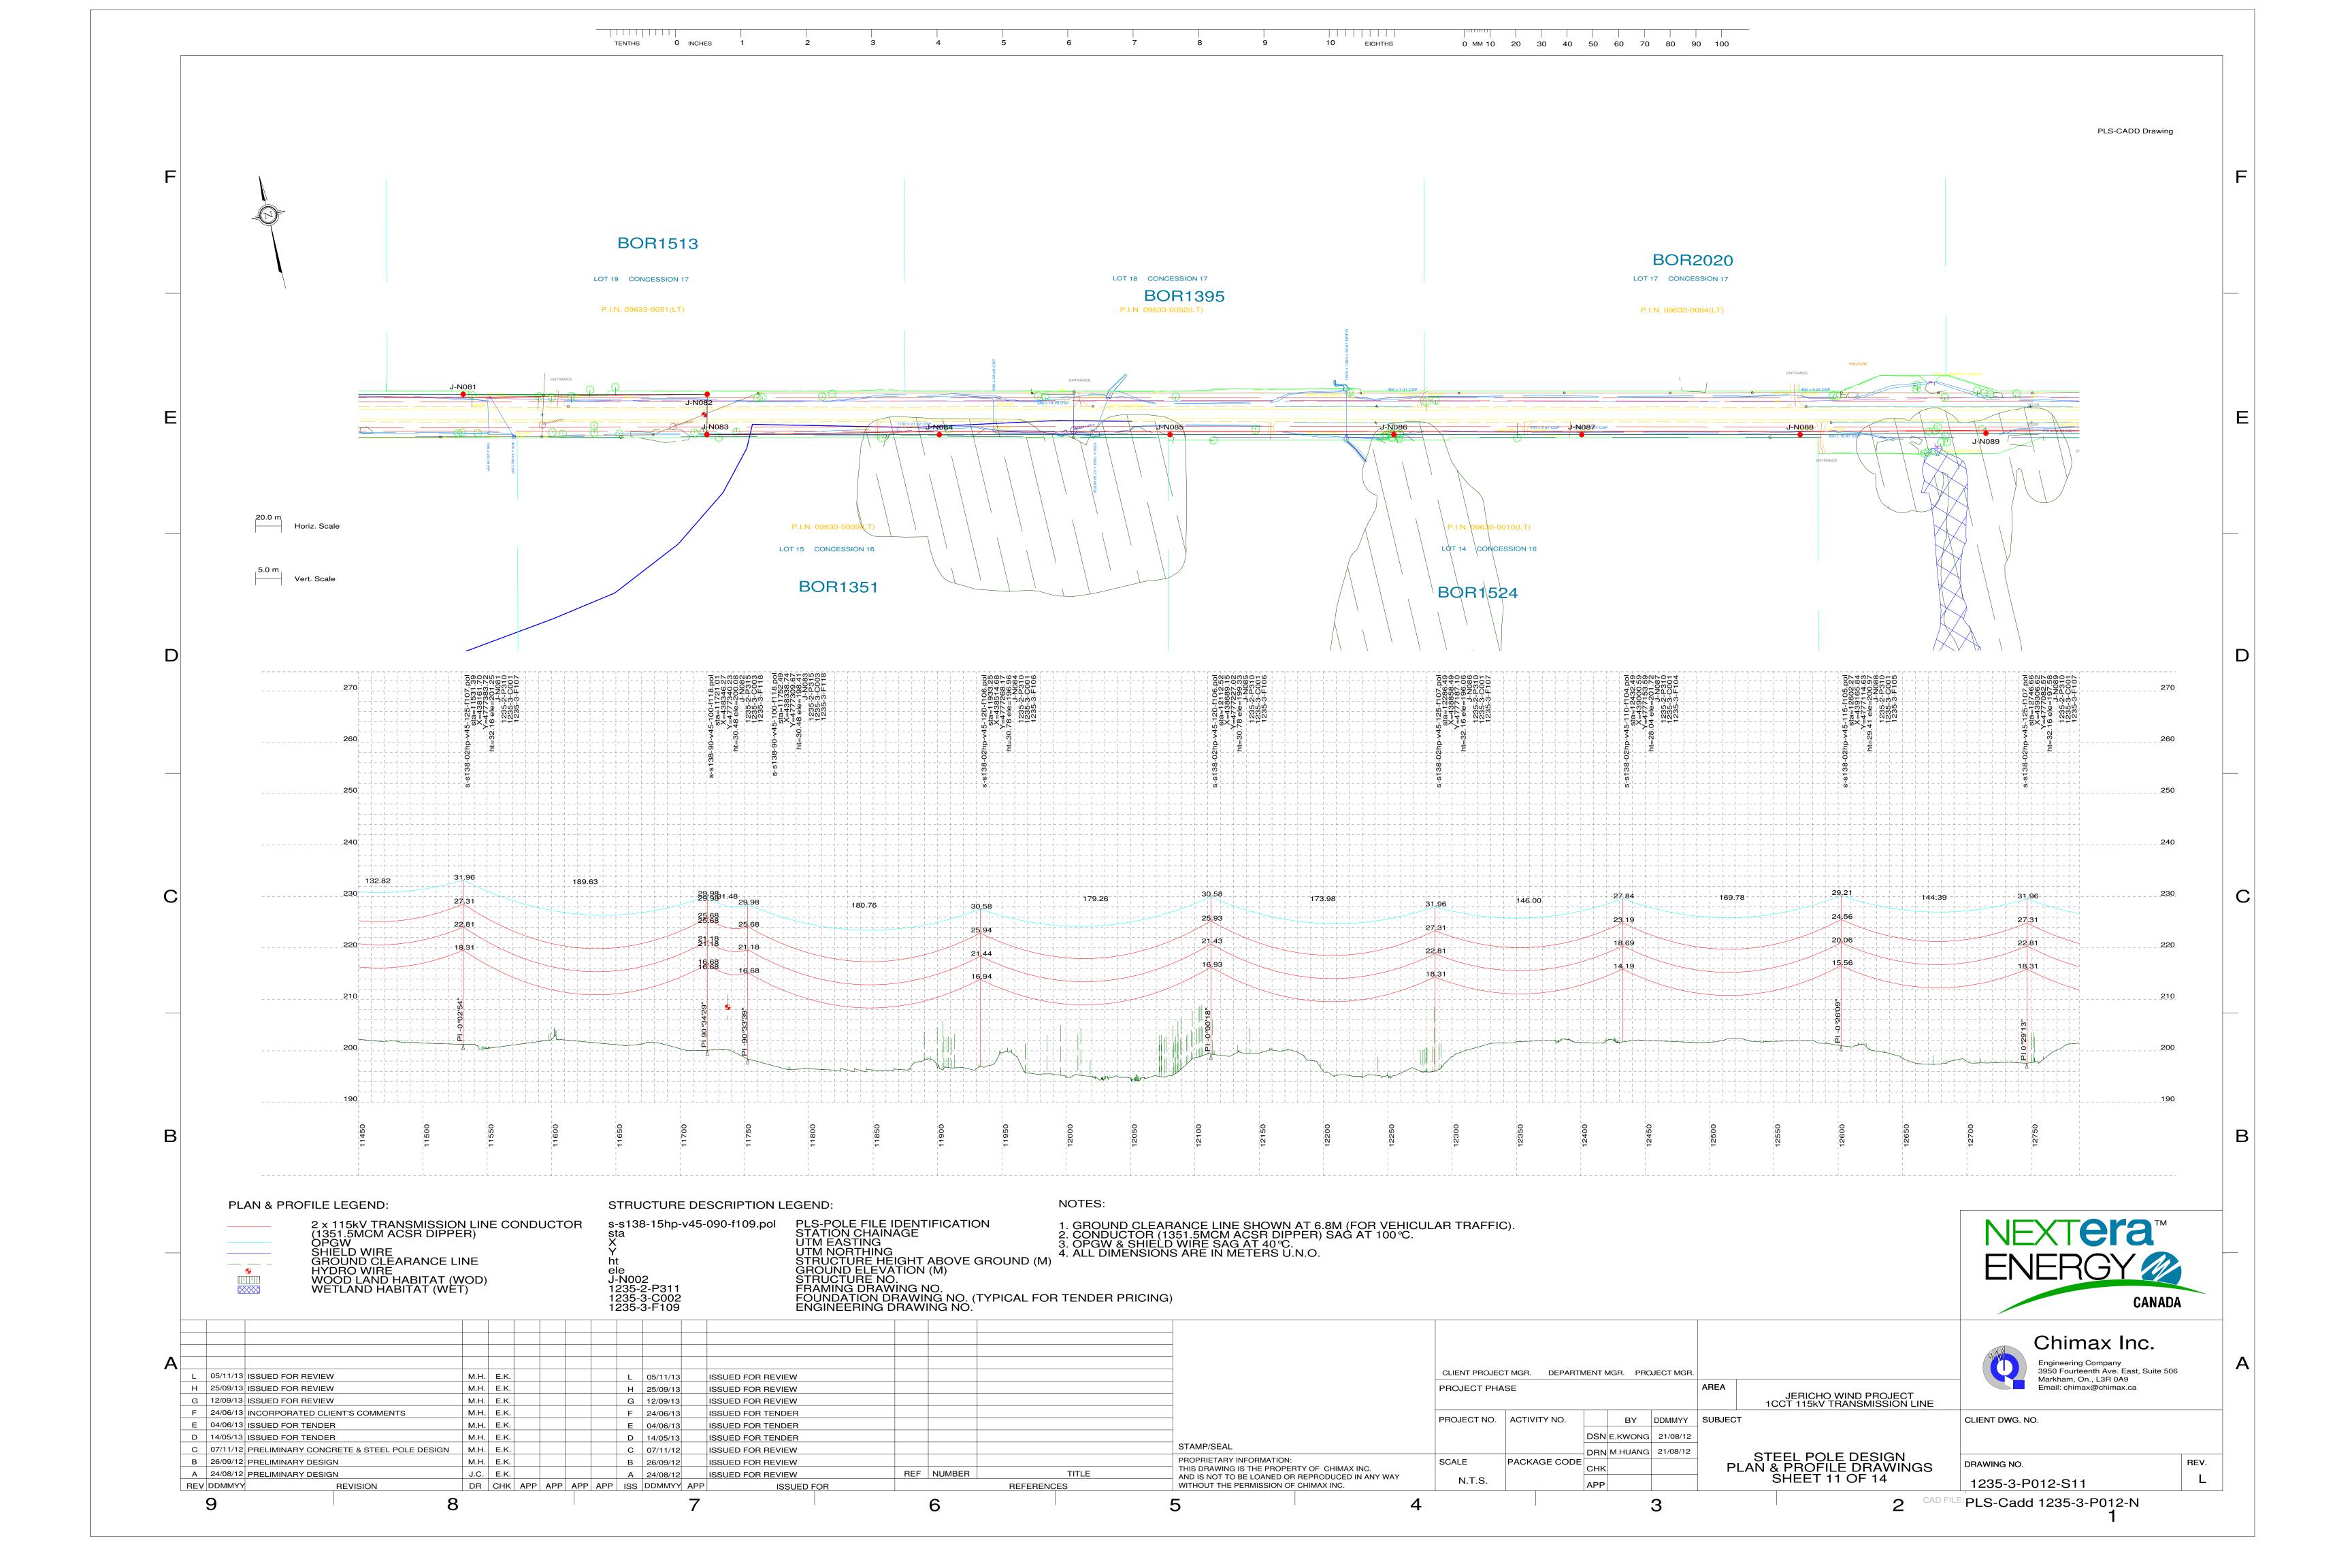

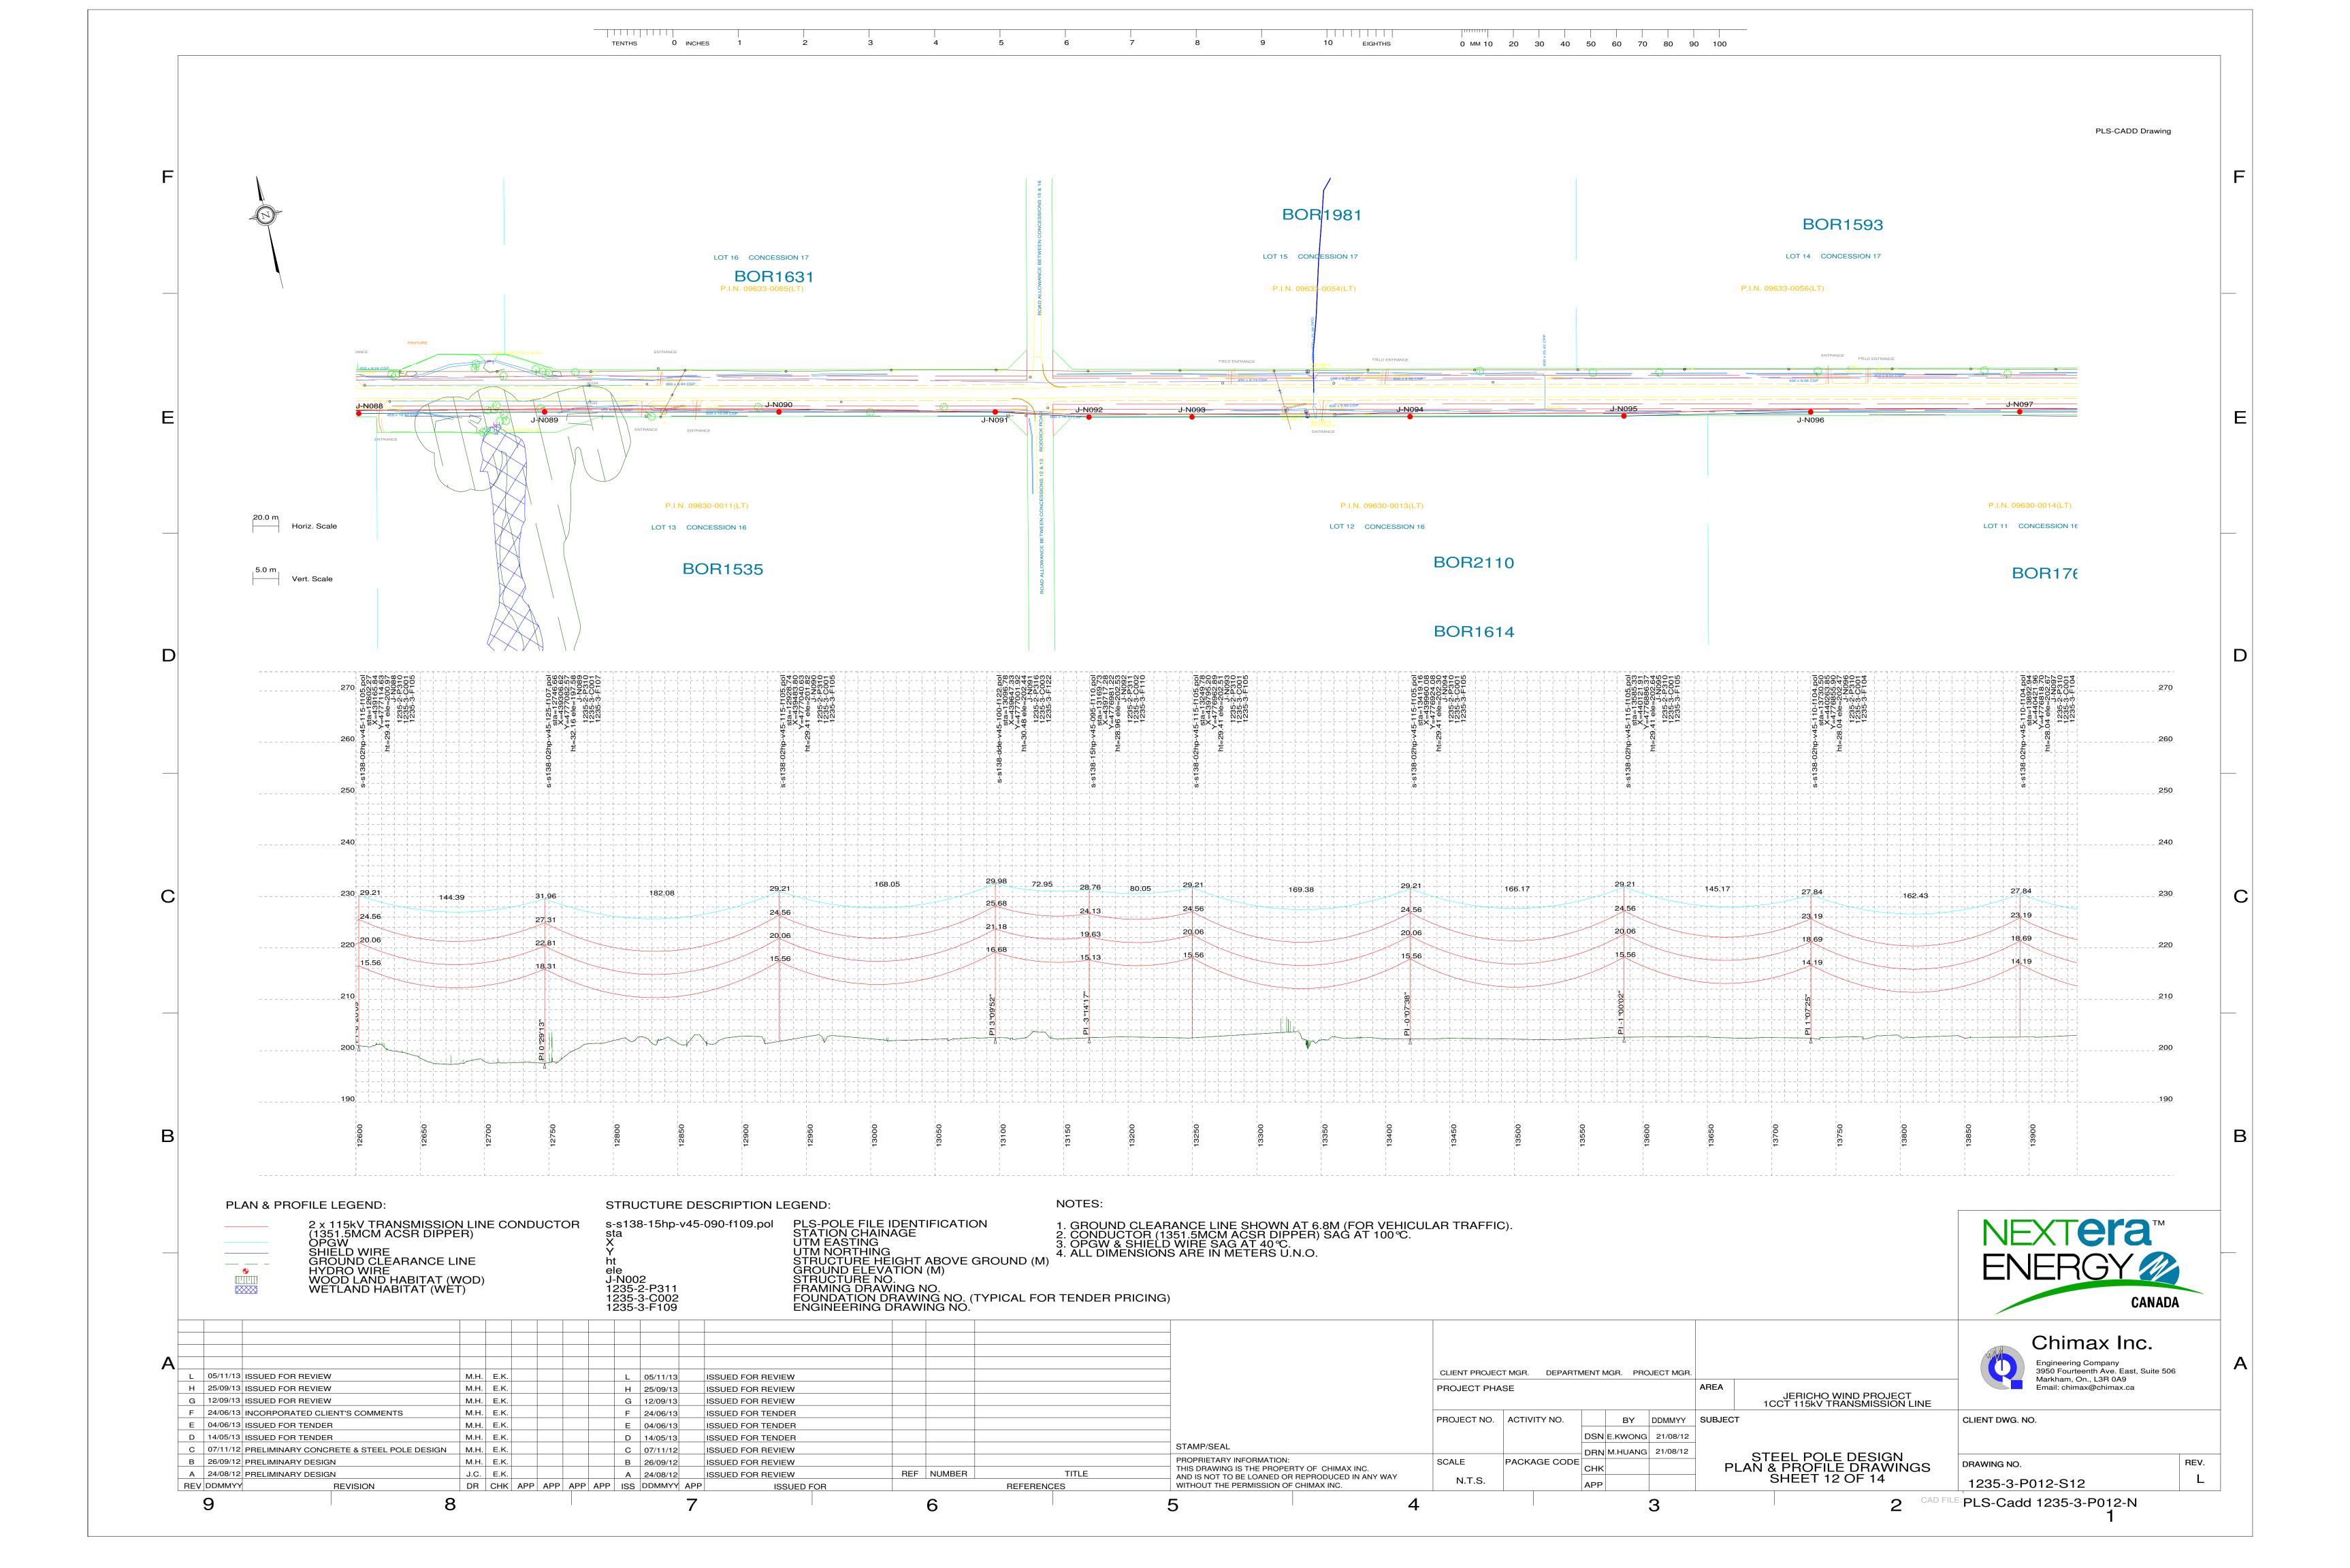

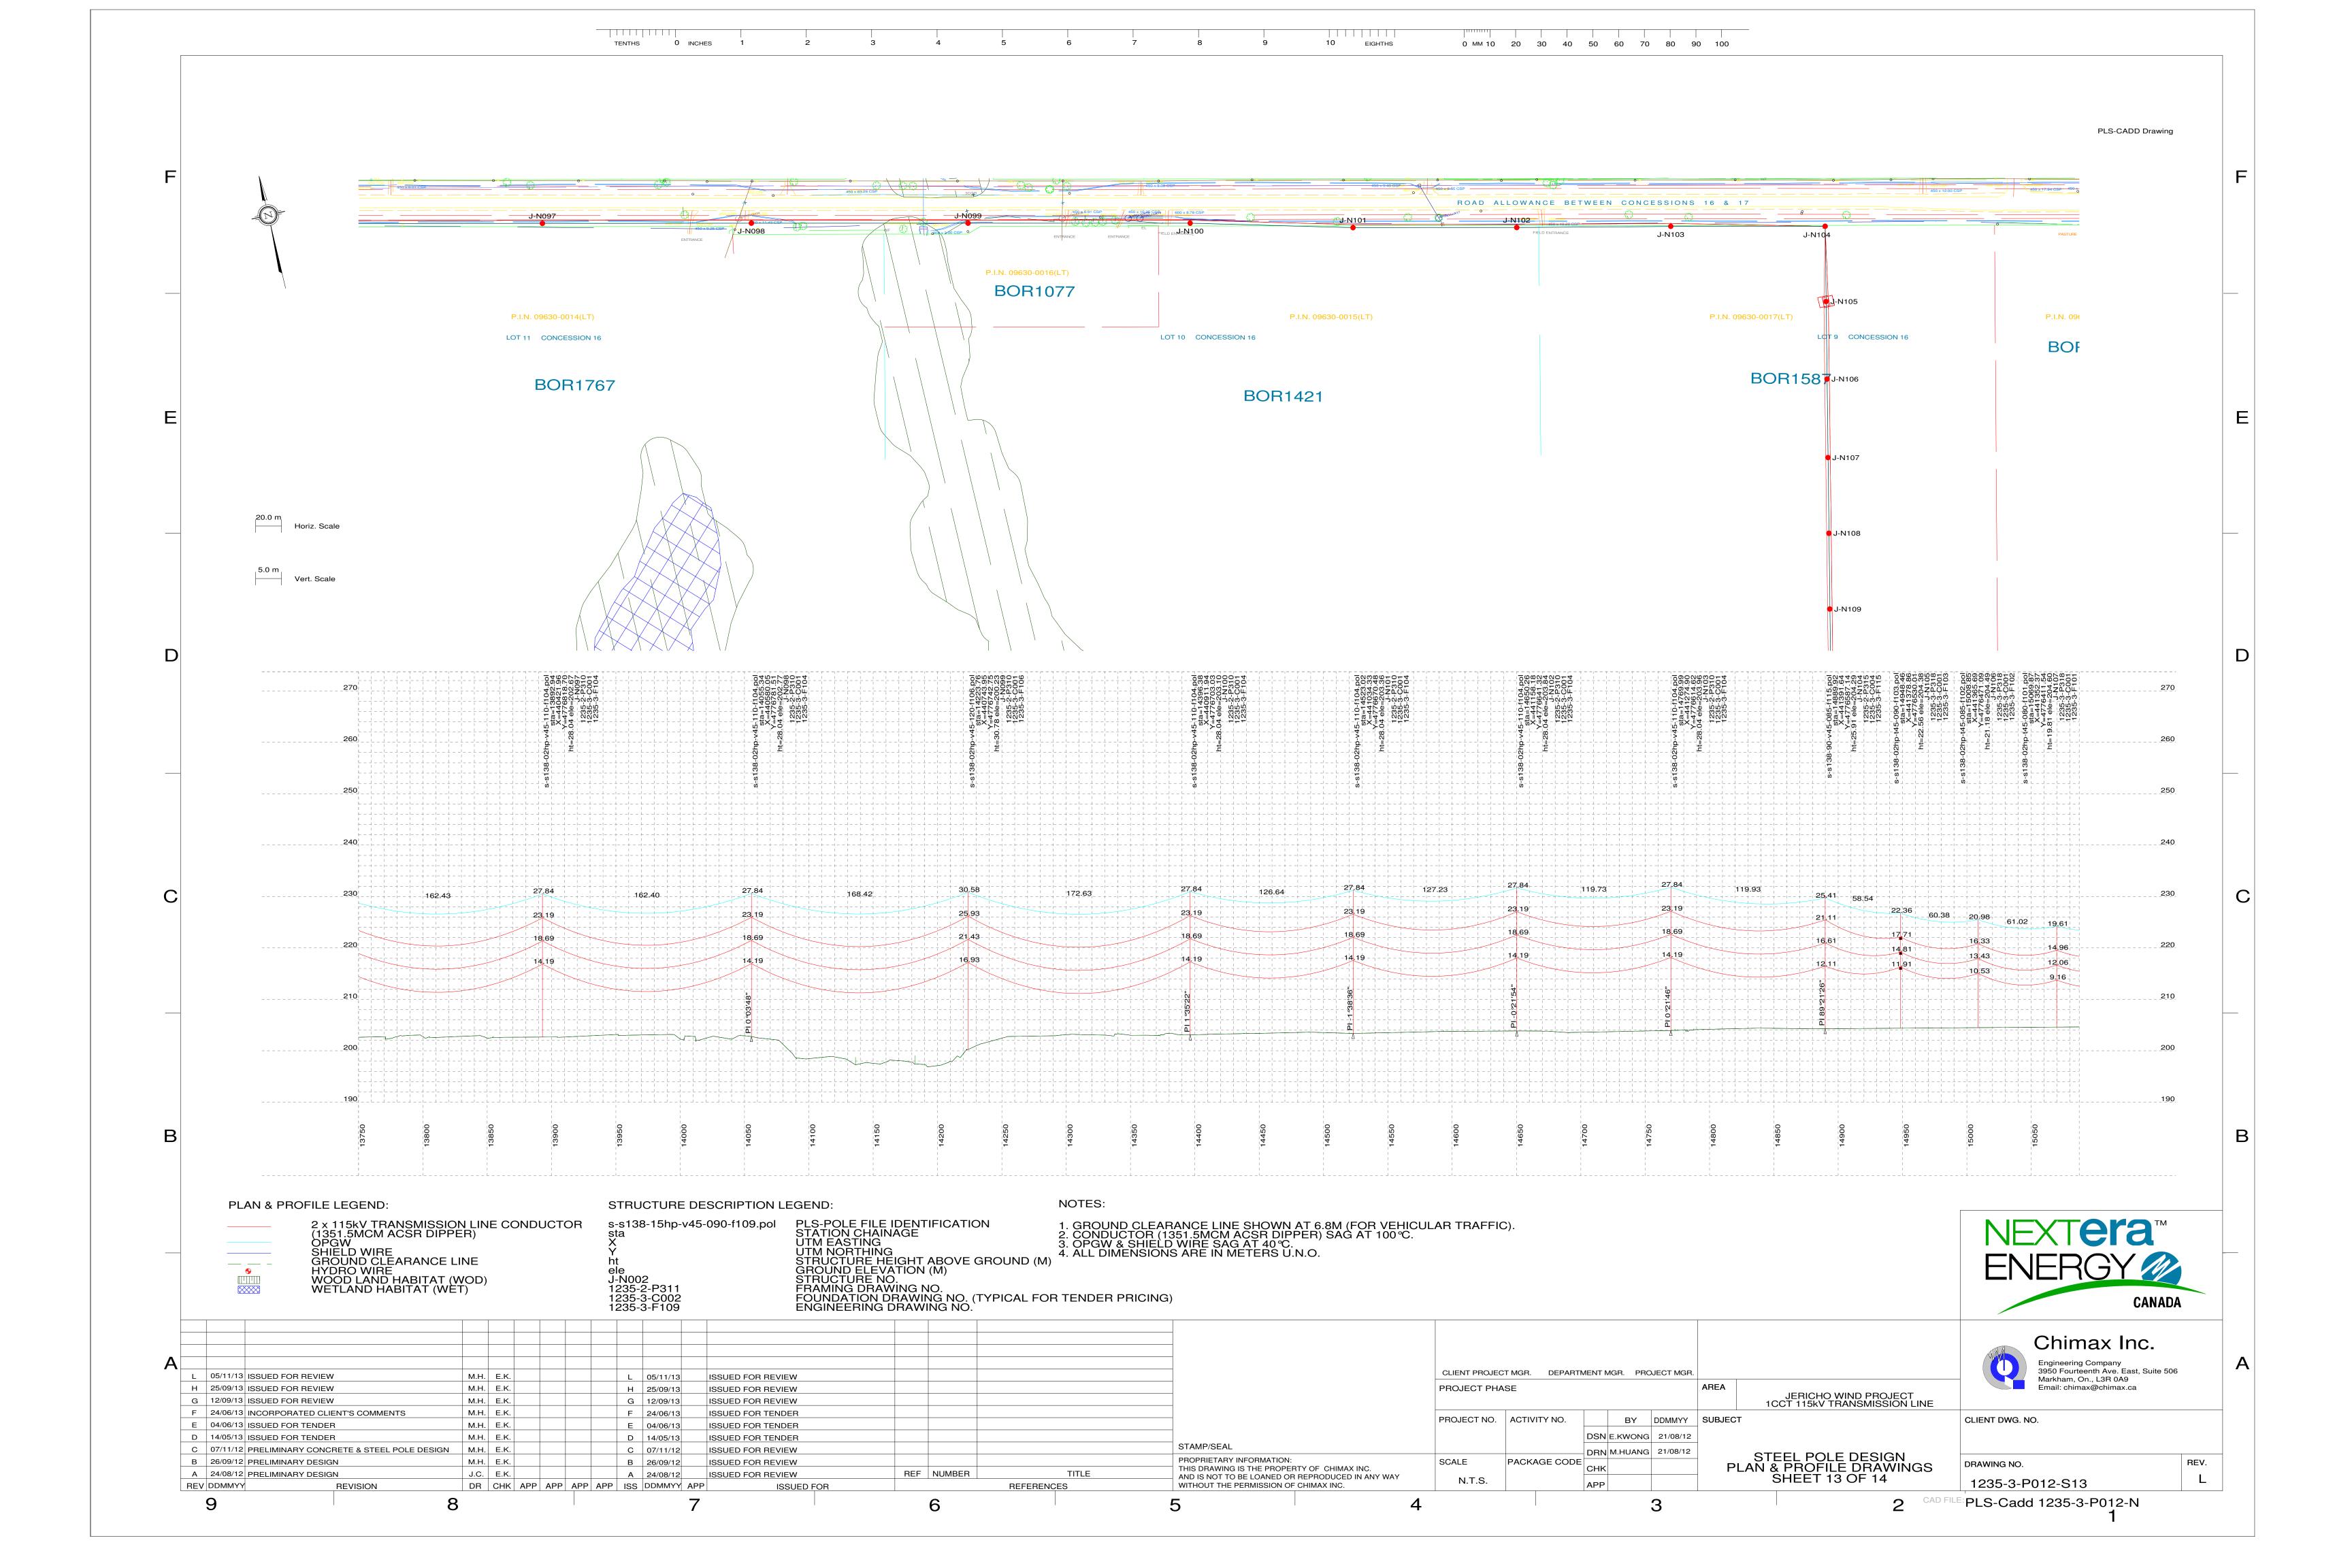


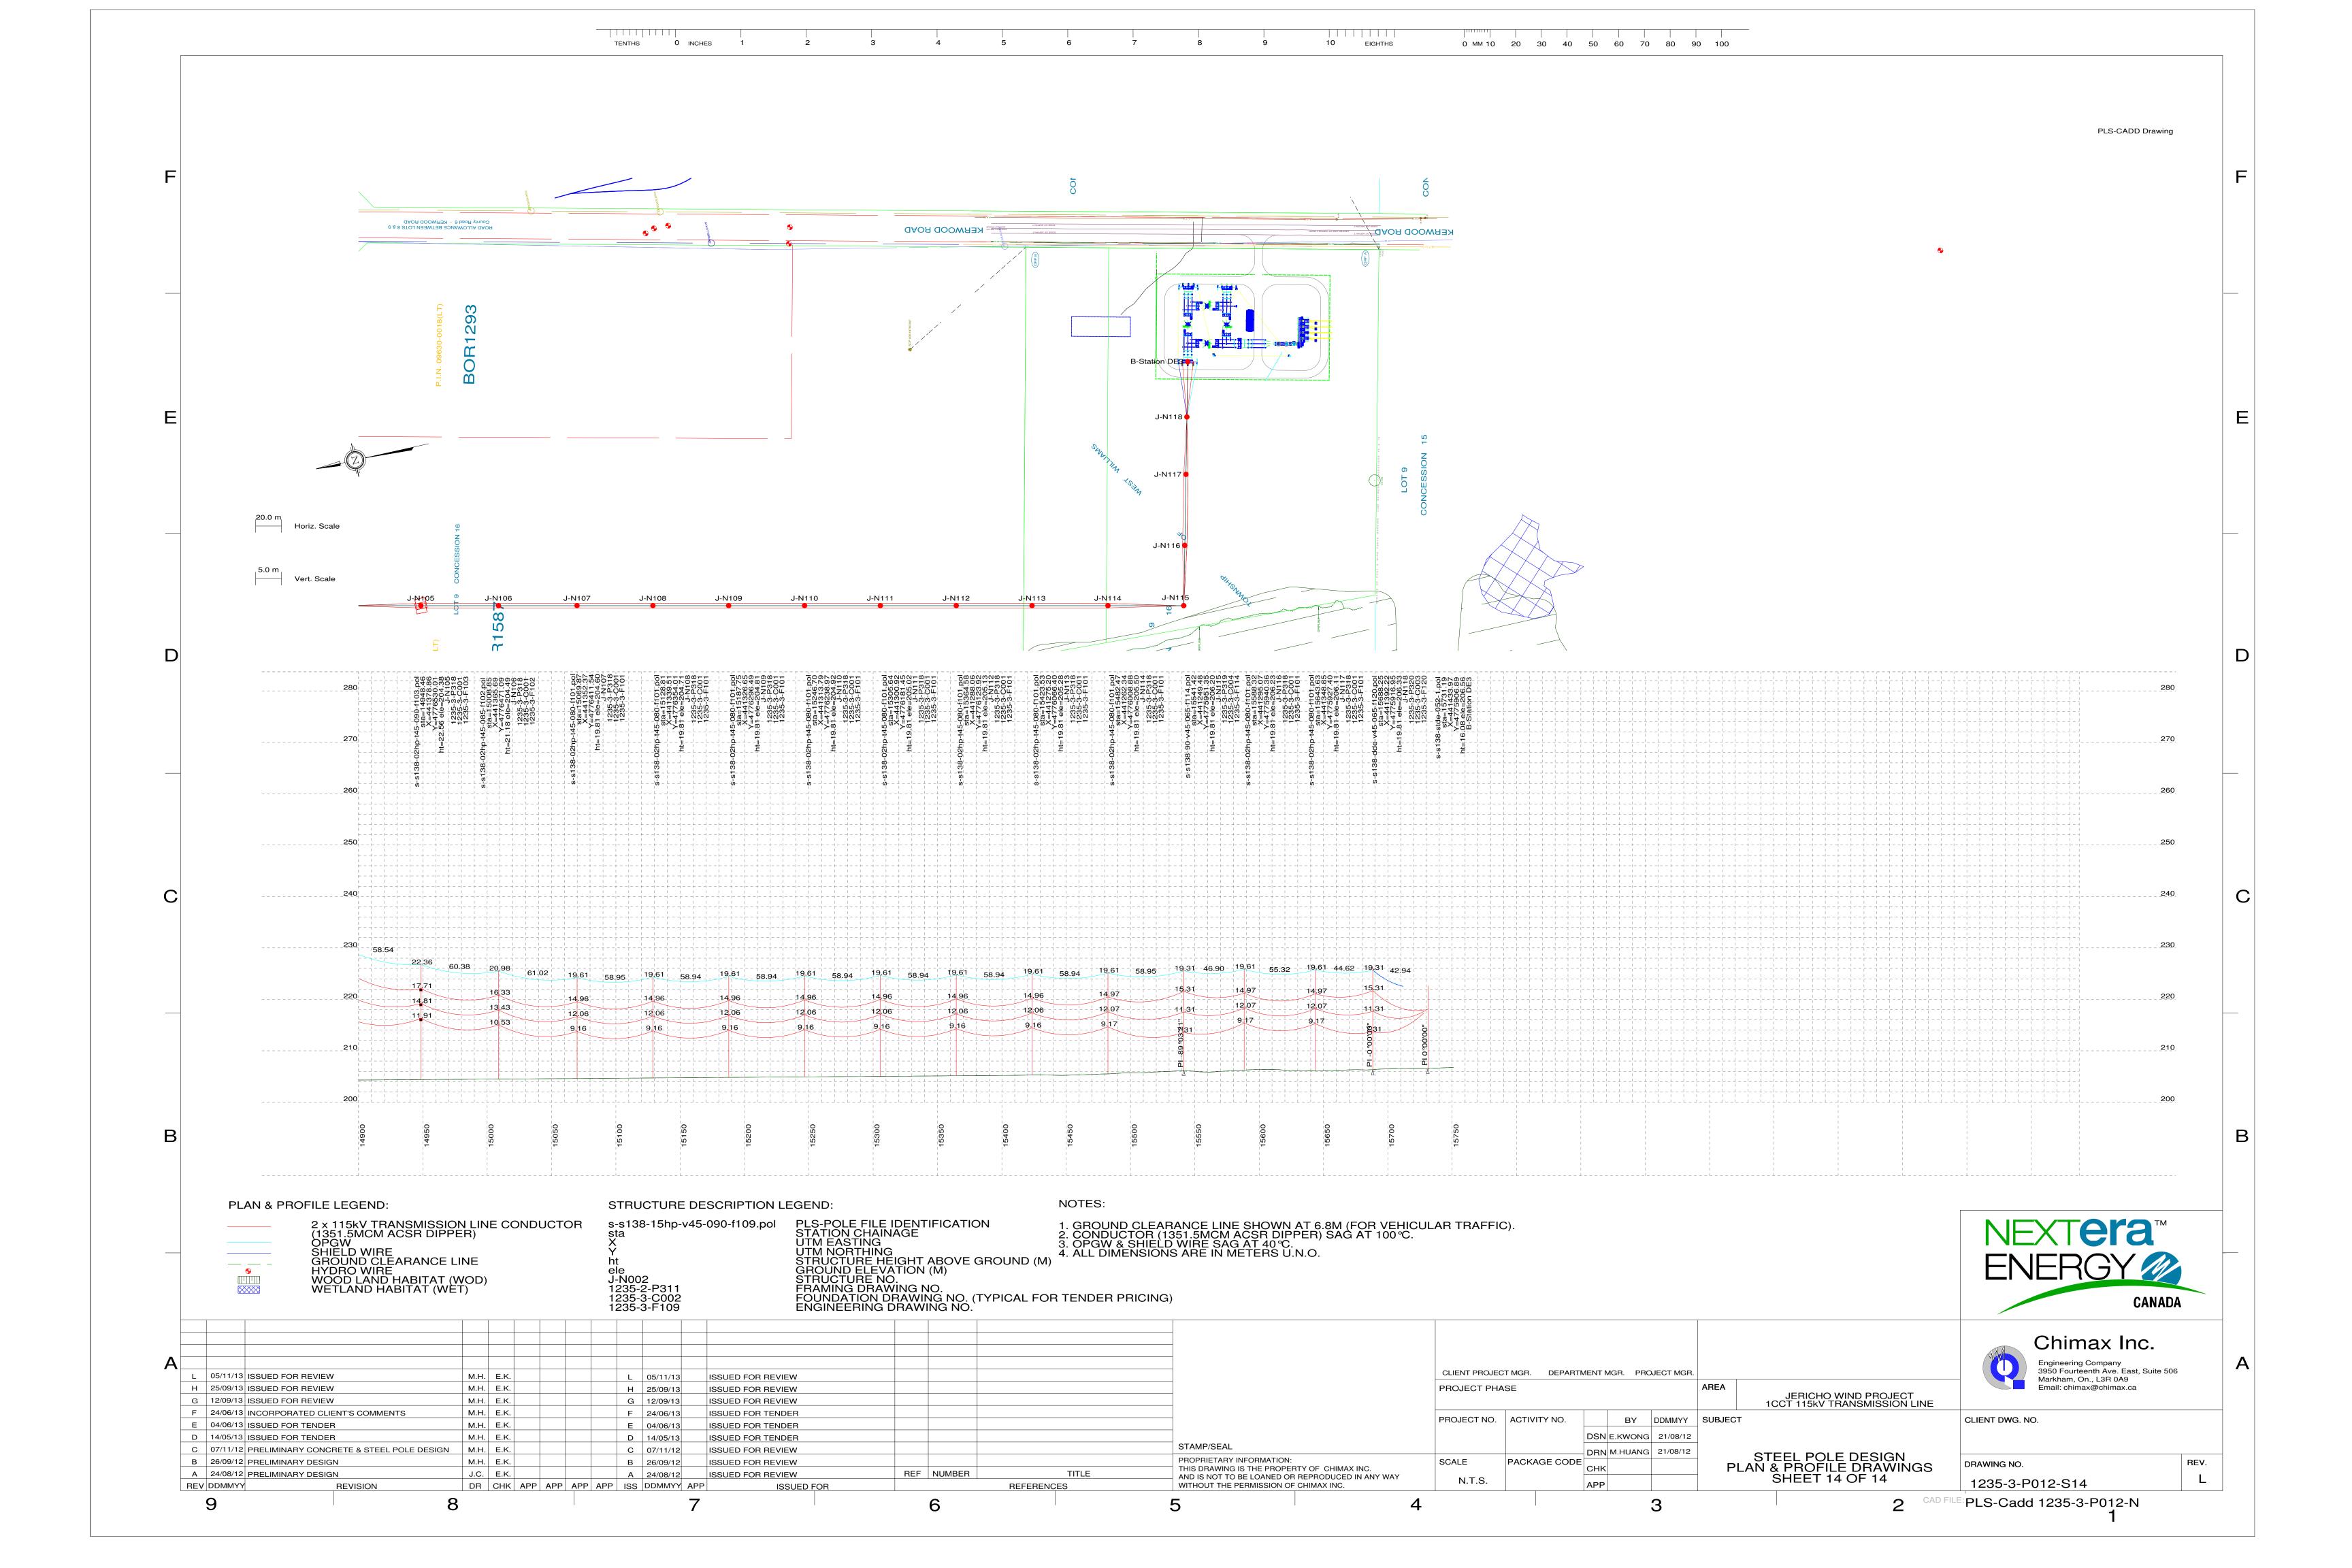



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ĥ	EXISTING SERVICES	DRAWING #, SOURCE	DATE	AS CONSTRUCTED SERVICES	COMPLETION	DETAILS	No.	REVISIONS	DATE	
ŝ						DESIGN RWC	1	MC ROAD USERS AGREEMENT	2013-11-05	
2						DRAWN BY MWB				
2						CHECKED RWC				
2						APPROVED RWC				
2						DATE 2013-08-29				
5										
5										
5						JTLsite G&G MC	dwa			
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<u>JERICHO TRANSMISSION LINE KEYPLAN</u> NOT TO SCALE

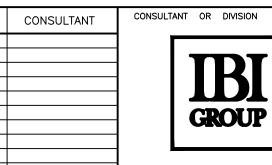


IBI Group 203 - 350 Oxford Street West London ON N6H 1T3 Canada ENGINEER'S STAMP

# NEXT ERA ENERGY

tel 519 472 7328 fax 519 472 9354

SCALE 1: 1000		PROJECT No. 34938
	JERICHO WIND ENERGY CENTRE MUNICIPALITY OF N. MIDDLESEX, COUNTY OF MIDDLESEX	
10 0 20m	Montell Altri of N. Middlesex, coontri of Middlesex	SHEET No.
	JERICHO TRANSMISSION LINE	CZS-1
		PLAN FILE No.

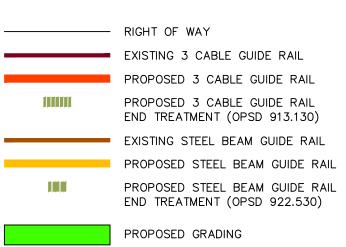

LEGEND FOR SHEETS CZS-1 TO CZS-7



						_			
EXISTING SERVICES	DRAWING #, SOURCE	DATE	AS CONSTRUCTED SERVICES	COMPLETION	DETAILS	No.	REVISIONS	DATE	CONSULTANT
					DESIGN RWC	1	MC ROAD USERS AGREEMENT	2013-11-05	
					DRAWN BY MWB				
					CHECKED RWC				
					APPROVED RWC				
					DATE 2013-08-29				
					JTLsite G&G MC	dwa			
					UTESILE G&G MC	.uwg			




**IBI Group** 203 - 350 Oxford Street West London ON N6H 1T3 Canada ENGINEER'S STAMP

tel 519 472 7328 fax 519 472 9354 NEXT ERA ENERGY

SCALE 1:1000	JERICHO WIND ENERGY CENTRE MUNICIPALITY OF N. MIDDLESEX, COUNTY OF MIDDLESEX	PROJECT No. 34938 SHEET No.
10 0 20m	JERICHO TRANSMISSION LINE J-N051 TO J-N067	CZS-2



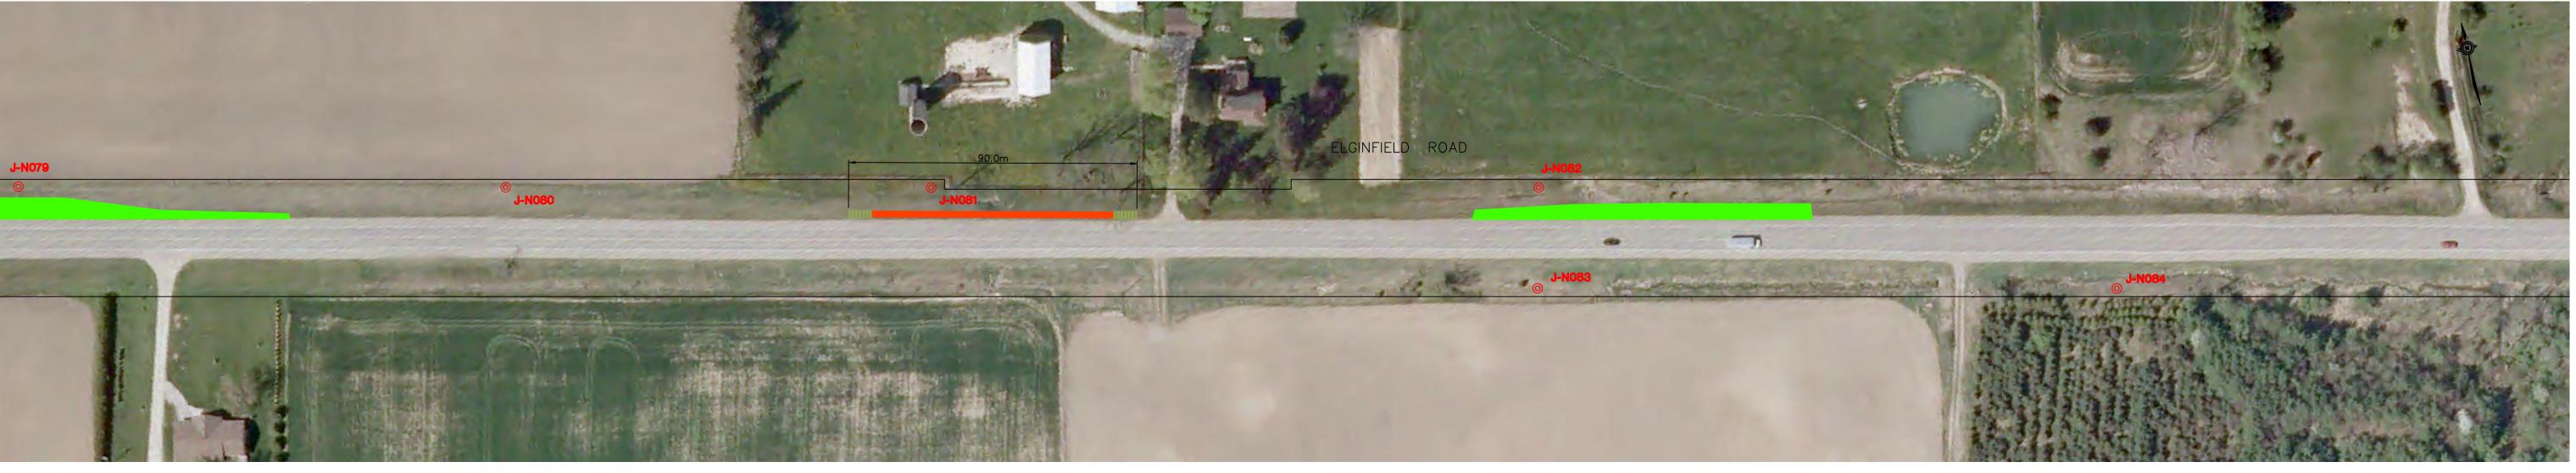

EXISTING SERVICES	DRAWING #, SOURCE	DATE	AS CONSTRUCTED SERVICES	COMPLETION	DETAILS	No.	REVISIONS	DATE	CONSULTANT
					DESIGN RWC	1	MC ROAD USERS AGREEMENT	2013-11-05	
					DRAWN BY MWB				
					CHECKED RWC				
					APPROVED RWC				
					DATE 2013-08-29				
					JTLsite G&G MC	dwa			
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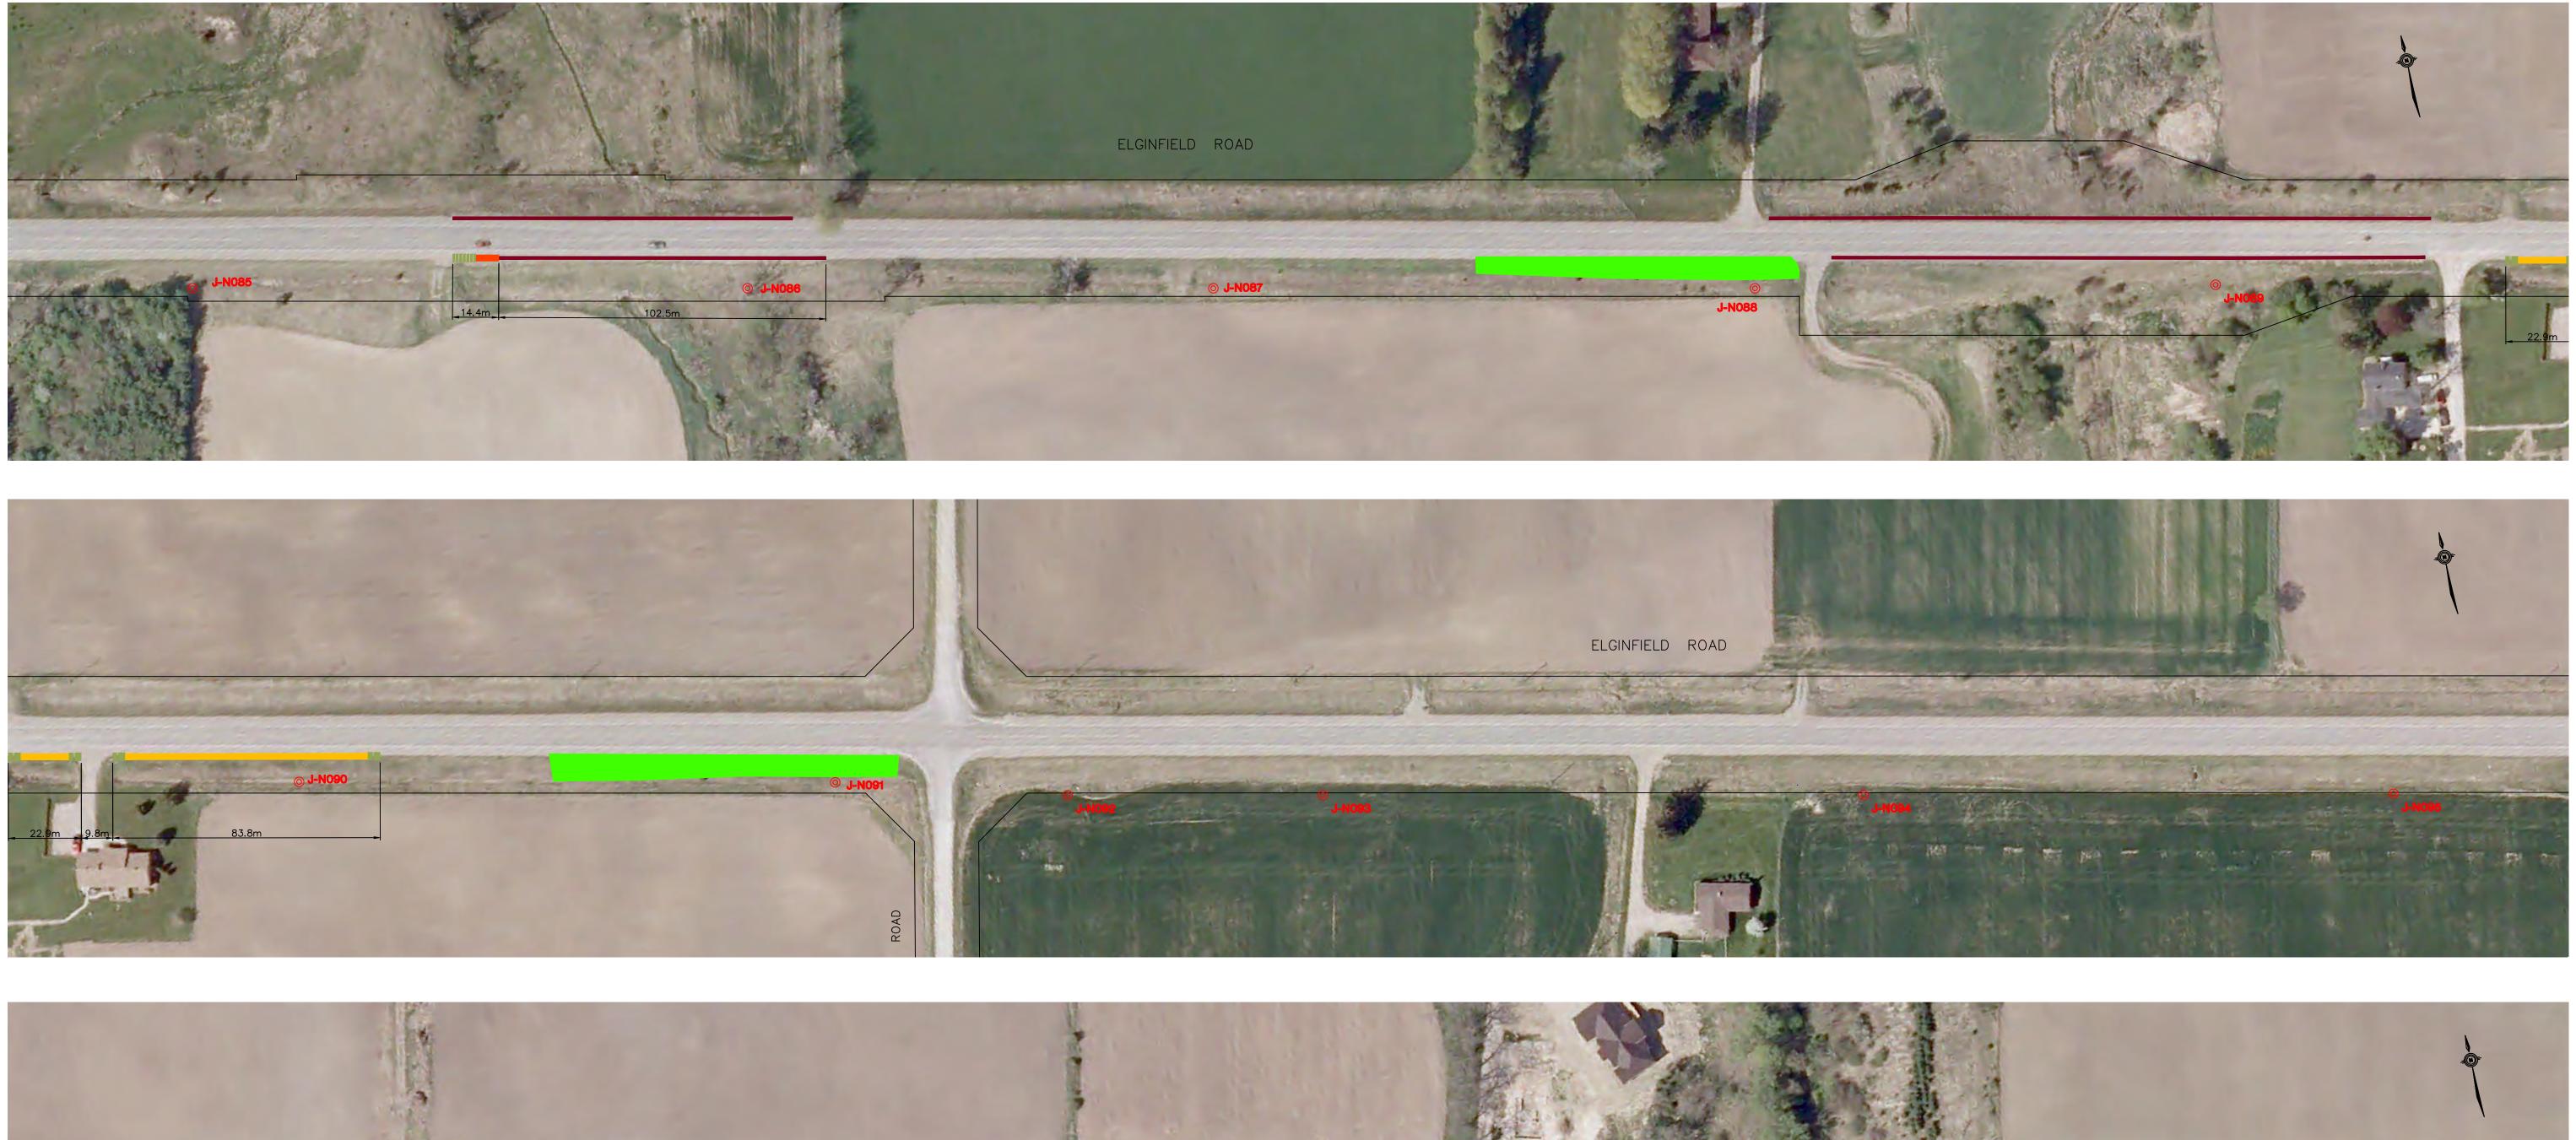


**IBI Group** 203 - 350 Oxford Street West London ON N6H 1T3 Canada ENGINEER'S STAMP

# NEXT ERA ENERGY

tel 519 472 7328 fax 519 472 9354

SCALE 1:1000	JERICHO WIND ENERGY CENTRE MUNICIPALITY OF N. MIDDLESEX, COUNTY OF MIDDLESEX	PROJECT No. 34938 SHEET No.
10 0 20m	JERICHO TRANSMISSION LINE	CZS-3
	J-N068 TO J-N084	PLAN FILE No.



EXISTING SERVICES	DRAWING #, SOURCE	DATE	AS CONSTRUCTED SERVICES	COMPLETION	DETAILS	No.	REVISIONS	DATE	CONSULTANT
					DESIGN RWC	1	MC ROAD USERS AGREEMENT	2013-11-05	
					DRAWN BY MWB				
					CHECKED RWC				
					APPROVED RWC				
					DATE 2013-08-29				
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					ULSILE G&G MC	.uwy			





ELGINFIELD ROAD

**IBI Group** 203 - 350 Oxford Street West London ON N6H 1T3 Canada ENGINEER'S STAMP

## NEXT ERA ENERGY

tel 519 472 7328 fax 519 472 9354

1:1000	JERICHO WIND ENERGY CENTRE MUNICIPALITY OF N. MIDDLESEX, COUNTY OF MIDDLESEX	PROJECT No. 34938 SHEET No.
	JERICHO TRANSMISSION LINE	CZS-4
	J-N085 TO J-N100	PLAN FILE No.



EXISTING SERVICES	DRAWING #, SOURCE	DATE	AS CONSTRUCTED SERVICES	COMPLETION	DETAILS	No.	REVISIONS	DATE	CONSULTANT
					DESIGN RWC	1	MC ROAD USERS AGREEMENT	2013-11-05	
					DRAWN BY MWB				
					CHECKED RWC				
					APPROVED RWC				
					DATE 2013-08-29				
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					OTESILE G&G MC	.uwy			



**IBI Group** 203 - 350 Oxford Street West London ON N6H 1T3 Canada

tel 519 472 7328 fax 519 472 9354

ENGINEER'S STAMP

NEXT ERA ENERGY

SCALE 1:1000	JERICHO WIND ENERGY CENTRE	PROJECT №. 34938
10 0 20m	JERICHO TRANSMISSION LINE	sheet no. CZS—5
	J-N101 TO J-N104	PLAN FILE No.

## SCHEDULE "C"

Appropriate Emergency Service Providers

## Schedule "C"

### **Appropriate Emergency Service Providers**

#### **Contact Information:**

#### **Ambulance Station**

Middlesex-London Emergency Medical Services Authority at 519-679-5466

#### **Fire Stations**

#### **Kerwood Fire Department**

*Kerwood Fire Station* 27817 Kerwood Road Kerwood, ON NOM 2B0

Fire Chief: Arend Noordhof kerwoodfiredept@bellnet.ca

#### Ailsa Craig and Parkhill Fire Departments

*Ailsa Craig Fire Station* 159 William Street, Alisa Craig, ON NOM 1A0

#### Parkhill Fire Station

194 Main Street, Parkhill, ON NOM 2K0

Contact Scott Jones: 519-494-6001

### **SCHEDULE "D"**

Permits and Fees

[See attached]

## Schedule ''D''

#### Permits and Fees

\* All references to legislation, by-laws and fees in this Schedule shall be interpreted as references to those by-laws and fees as they may be amended, superseded or replaced from time to time

Permit Required with Appropriate Application	Cost
Access/Entrance Permit (authorizing access, via entrance application)	\$400 fee + refundable deposit determined by County Engineer
Work Permit (authorizing work and/or services, via work application)	\$400 fee + refundable deposit determined by County Engineer
Moving Oversize Load/Weight Vehicles on County Roads Permit (via application with utility company and emergency services sign-offs)	Variable fee between \$50 and \$500 depending on dimensions and weight of load + \$500 refundable deposit (\$2M liability insurance required)
	Access/Entrance Permit (authorizing access, via entrance application) Work Permit (authorizing work and/or services, via work application) Moving Oversize Load/Weight Vehicles on County Roads Permit (via application with utility company and

#### **SCHEDULE "E"**

#### Rights and Remedies Accorded to Secured Parties

1. The County will from time to time execute and deliver such consents and acknowledgements reasonably requested by the Secured Party.

2. The County agrees that, upon the Secured Party giving the County written notice of any security granted by Jericho in the Agreement, the Secured Party will, without any further action being required, have the benefit of the following provisions until such time as the Secured Party advises the County in writing that its security is no longer in effect (and, if the Secured Party so requests, the County will (i) acknowledge in writing that the Secured Party so benefits from these provisions, or (ii) enter into a written agreement with the Secured Party substantially in accordance with these provisions):

- (a) the County will give prompt written notice to the Secured Party of any breach or default by Jericho of its obligations under the Agreement in respect of which the County proposes to exercise any of its remedies;
- (b) the County will give the Secured Party the right to cure any breach or default by Jericho under the Agreement, within a period of 90 days commencing on the later of (i) the expiry of the cure period afforded Jericho under the Agreement, and (ii) the date on which the County gives the Secured Party notice of such breach or default pursuant to Section 2(a), or such longer period of time as the Secured Party may reasonably require to cure such breach or default; and no exercise by the County of any of its rights or remedies against Jericho will be effective against Jericho or the Secured Party unless the County has provided the Secured Party such notice and opportunity to cure.
- (c) the County will, at any time and from time to time, upon not less than ten (10) days' prior request by Jericho or the Secured Party or proposed the Secured Party, execute any agreements, certificates or acknowledgements that Jericho or the Secured Party may reasonably request with respect to this Agreement; and
- (d) all notices to the Secured Party from the County will be in writing and will be sent by personal delivery, registered mail, email or by fax to the address, email address or facsimile number of the Secured Party set out in any notice that the Secured Party delivers to the County.

3. The provisions of Section 2 will enure to the benefit of the Secured Party and its successors and assigns, and any rights conferred on the Secured Party by the terms of this Agreement or limiting its liability under the Agreement will benefit each receiver or receivermanager appointed by the Secured Party or by a court of competent jurisdiction.

5. The County hereby acknowledges that Jericho may grant security to a trustee or collateral agent acting on behalf of one or more lenders (a "**Collateral Agent**"), and the County hereby acknowledges and agrees that upon its receipt of notice that such security was granted, the

Collateral Agent will be entitled to all of the rights of the Secured Party set forth in this and such notice will constitute notice of the existence of the Collateral Agent as the Secured Party.